

CAMERON BLVD - EXISTING CONDITIONS

CAMERON BLVD - EXISTING CONDITIONS

STUDENT UNION - EXISTING CONDITIONS

MAIN STATION - EXISTING CONDITIONS

LOT 11 - EXISTING CONDITIONS

J.W. CLAY - DEMOLITION PLAN

EROSION CONTROL PLAN

EROSION CONTROL PLAN

EROSION CONTROL PLAN

EROSION CONTROL PLAN

MAIN STATION - UTILITY PLAN

J.W. CLAY - PLANTING PLAN

MAIN STATION - PLANTING PLAN

CAMERON BLVD - PLANTING PLAN

STUDENT UNION - PLANTING PLAN

J.W. CLAY - EXISTING CONDITIONS

MAIN STATION - DEMOLITION PLAN

CAMERON BLVD - DEMOLITION PLAN

STUDENT UNION - DEMOLITION PLAN

MAIN STATION - STAKING & MATERIALS PLAN

J.W. CLAY - STAKING & MATERIALS PLAN

J.W. CLAY - GRADING, DRAINAGE, AND

MAIN STATION - GRADING, DRAINAGE AND

CAMERON BLVD - STAKING & MATERIALS PLAN

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Land Planning

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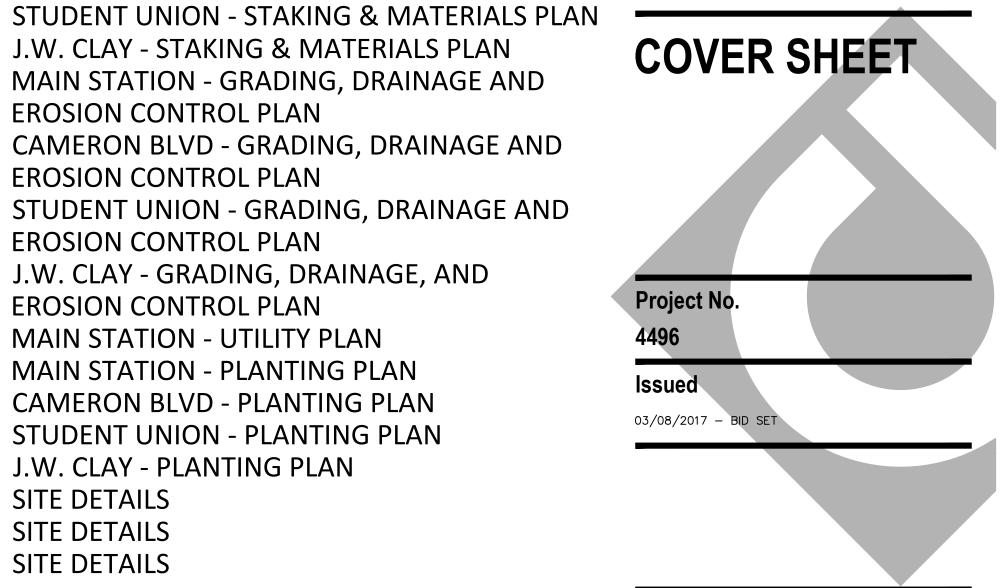
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CAMPUS CIRCULATION IMPROVEMENTS

SCO ID# 16-14055 **CODE 41526 ITEM 310**



COMPANY: ALTA PLANNING AND DESIGN

SITE DETAILS

SITE DETAILS

SITE DETAILS

SHEET NUMBER SHEET TITLE

SHEET INDEX

SHEET NUMBER

C-000

C-001

V-100

V-101

V-102

V-103

V-104

V-105

C-100

C-101

C-102

C-202

C-401

C-402

C-500

C-701

C-702

C-703

C-800

C-801

C-802

COMPANY: COLE JENEST & STONE

SHEET TITLE

COVER SHEET

APPENDIX B

C-900 MAIN STATION - SIGNAGE AND PAVEMENT

MARKING PLAN

C-901 **MAIN STATION - SIGNAL PLAN**

COMPANY: ELM ENGINEERING

SHEET NUMBER

ELECTRICAL COVER SHEET E-100

EXISTING ELECTRICAL POWER RISER DIAGRAM E-101 E-102 ELECTRICAL DETAILS

E-103 PANELBOARD SCHEDULE AND DETAILS

E-200 MAIN STATION - SITE PLAN BASE BID/ALT.#4,5 E-201 CAMERON BLVD - SITE PLAN E-202 STUDENT UNION - SITE PLAN

COMPANY: IRRIGATION INNOVATIONS

SHEET NUMBER SHEET TITLE

MAIN STATION - IRRIGATION PLAN MAIN STATION - IRRIGATION DETAILS North 21

IRRIGATION INNOVATIONS

4218 CAHNNAS WAY

WAXHAW, NC 28173


(704) 256-4873

1. CONTRACTOR IS FULLY RESPONSIBLE FOR CONTACTING APPROPRIATE PARTIES AND ASSURING THAT EXISTING UTILITIES ARE

LOCATED PRIOR TO CONSTRUCTION. 2. CONTRACTOR IS RESPONSIBLE FOR PLACING BARRICADES USING FLAG MEN, ETC. AS NECESSARY TO INSURE SAFETY TO THE PUBLIC 3. SHORING WILL BE ACCORDING TO OSHA TRENCHING STANDARDS PART 1926 SUBPART P. OR AS AMENDED.

4. CONTRACTOR SHALL COORDINATE ALL LOCATES WITH THE UNC CHARLOTTE CONSTRUCTION MANAGE WITH A MINIMUM OF 96 HOURS


PRIOR TO CONSTRUCTION.

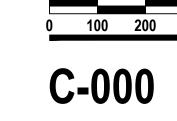



Revised


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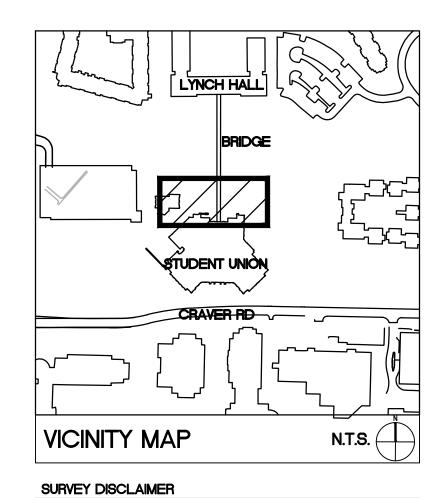
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PAVERS TO BE REMOVED

VEGETATION TO BE RELOCATED

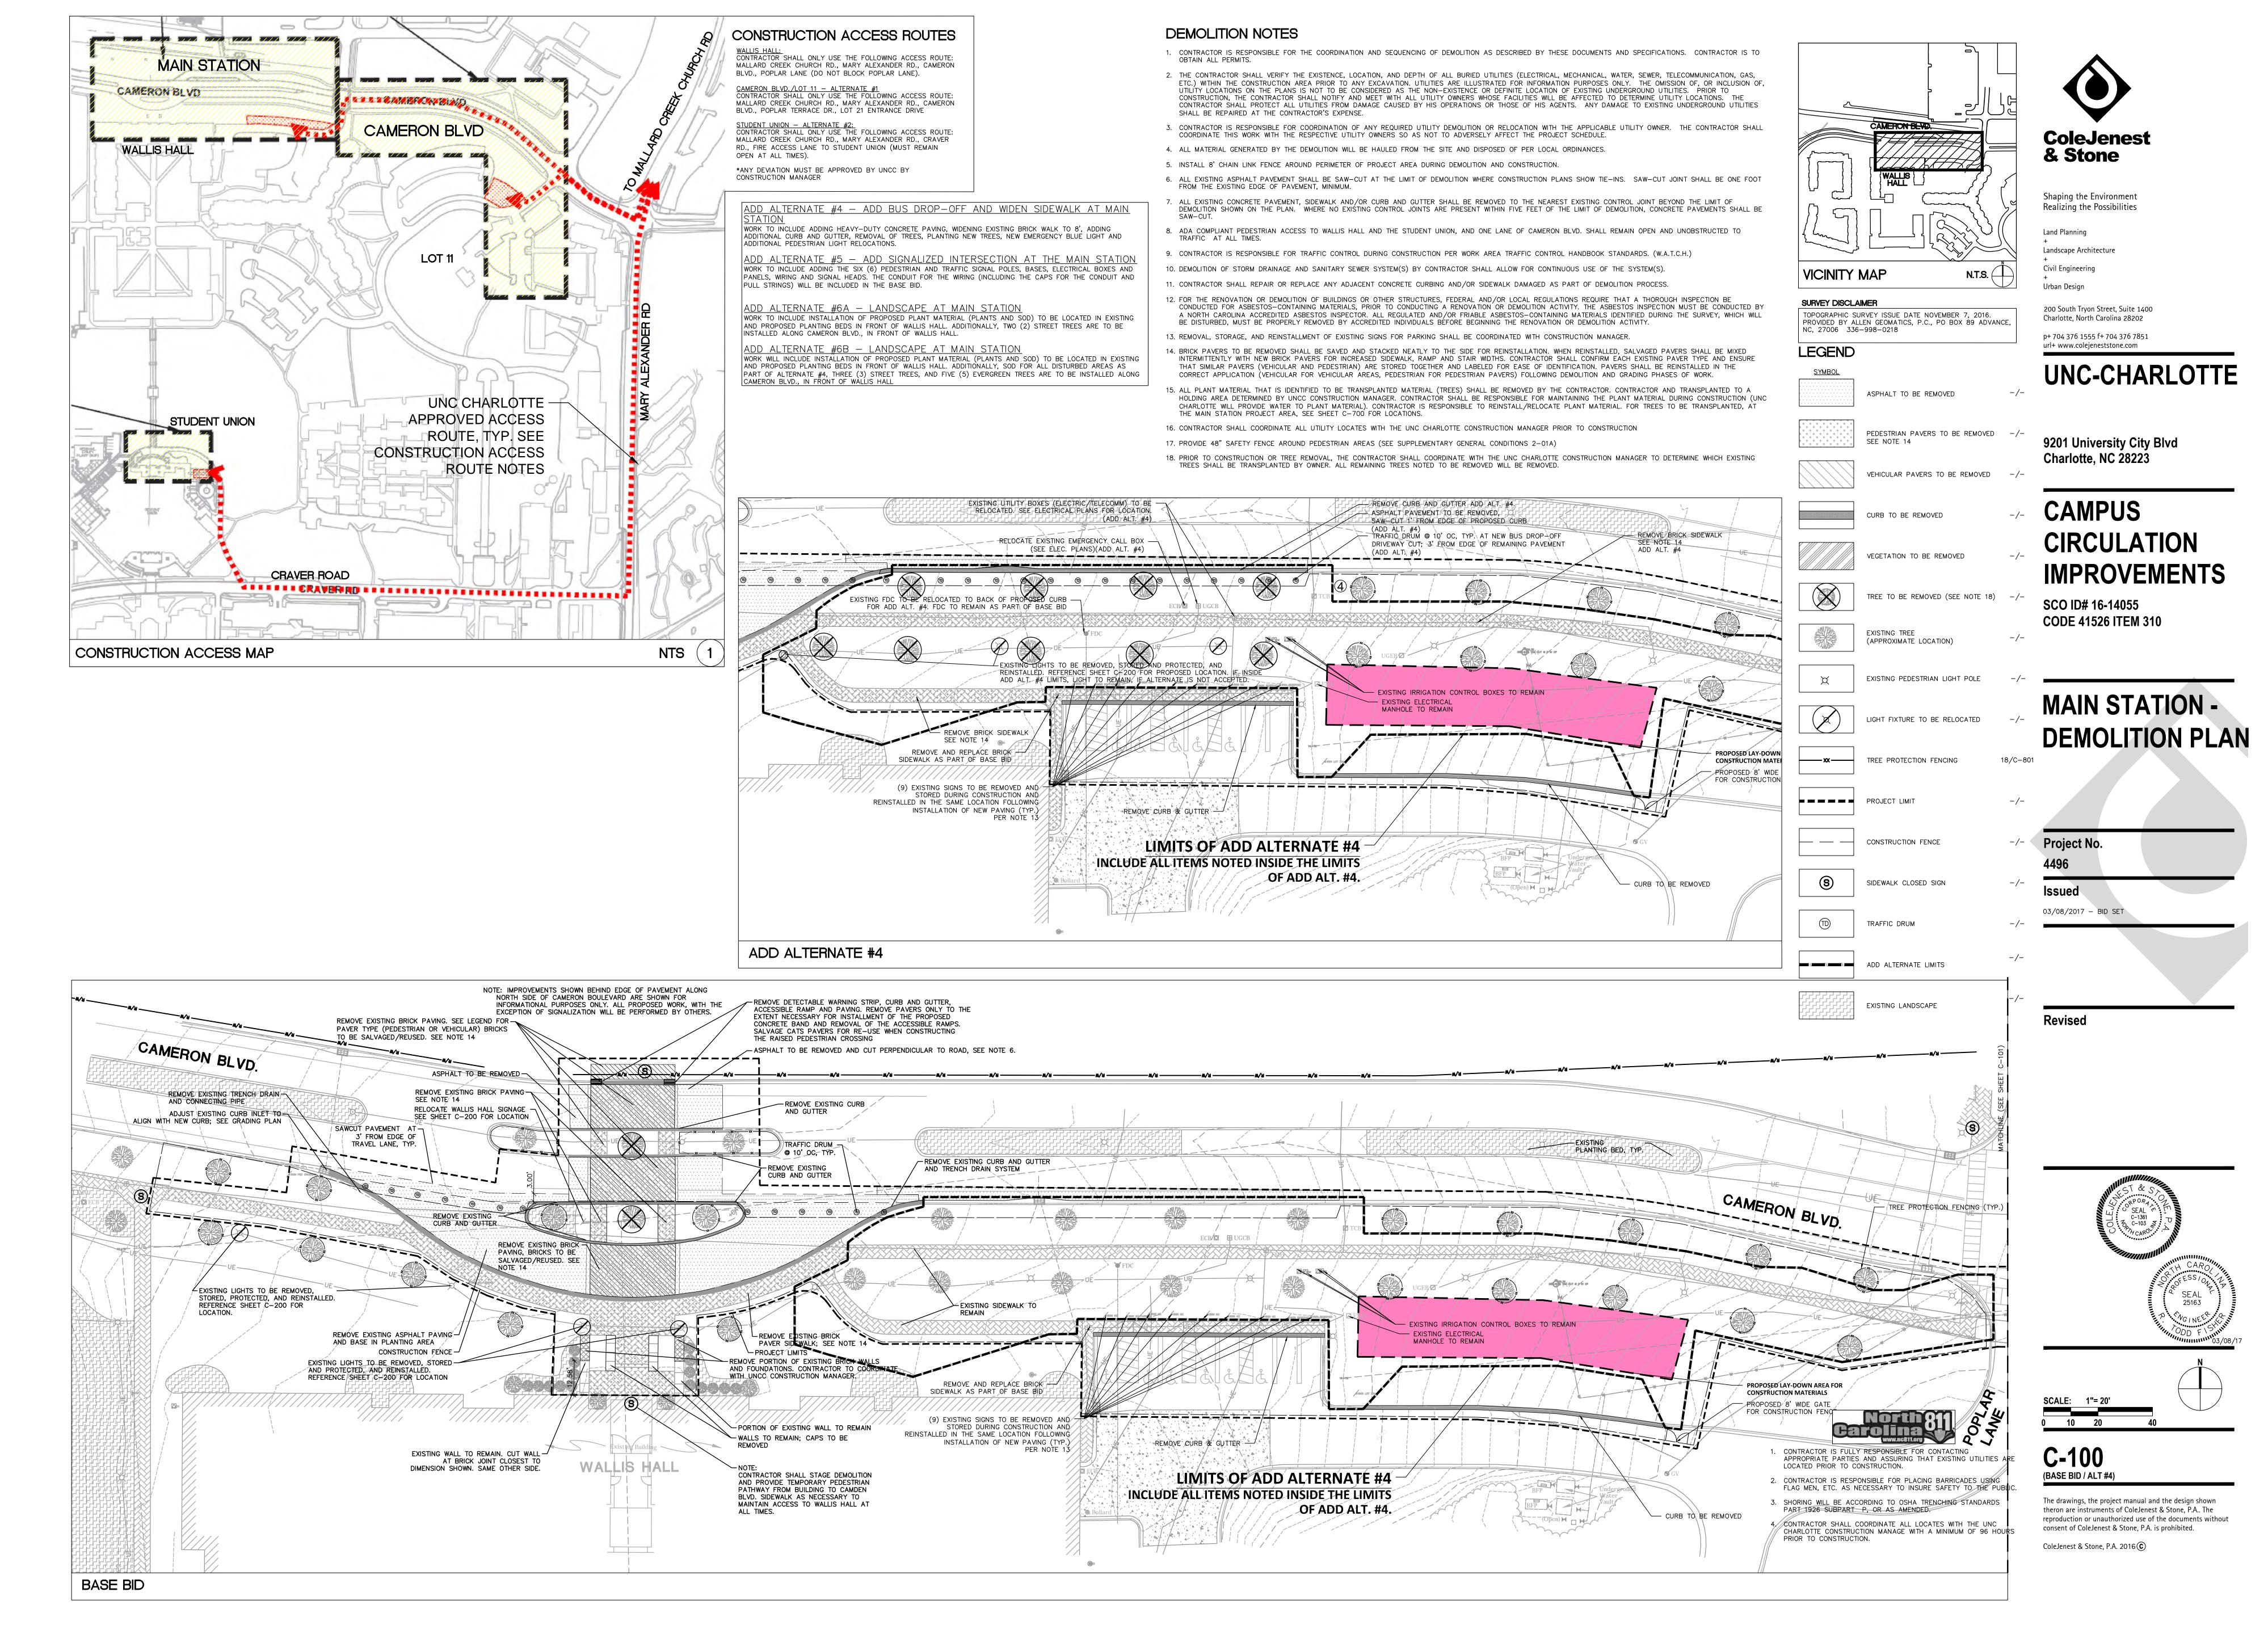TREE PROTECTION FENCING

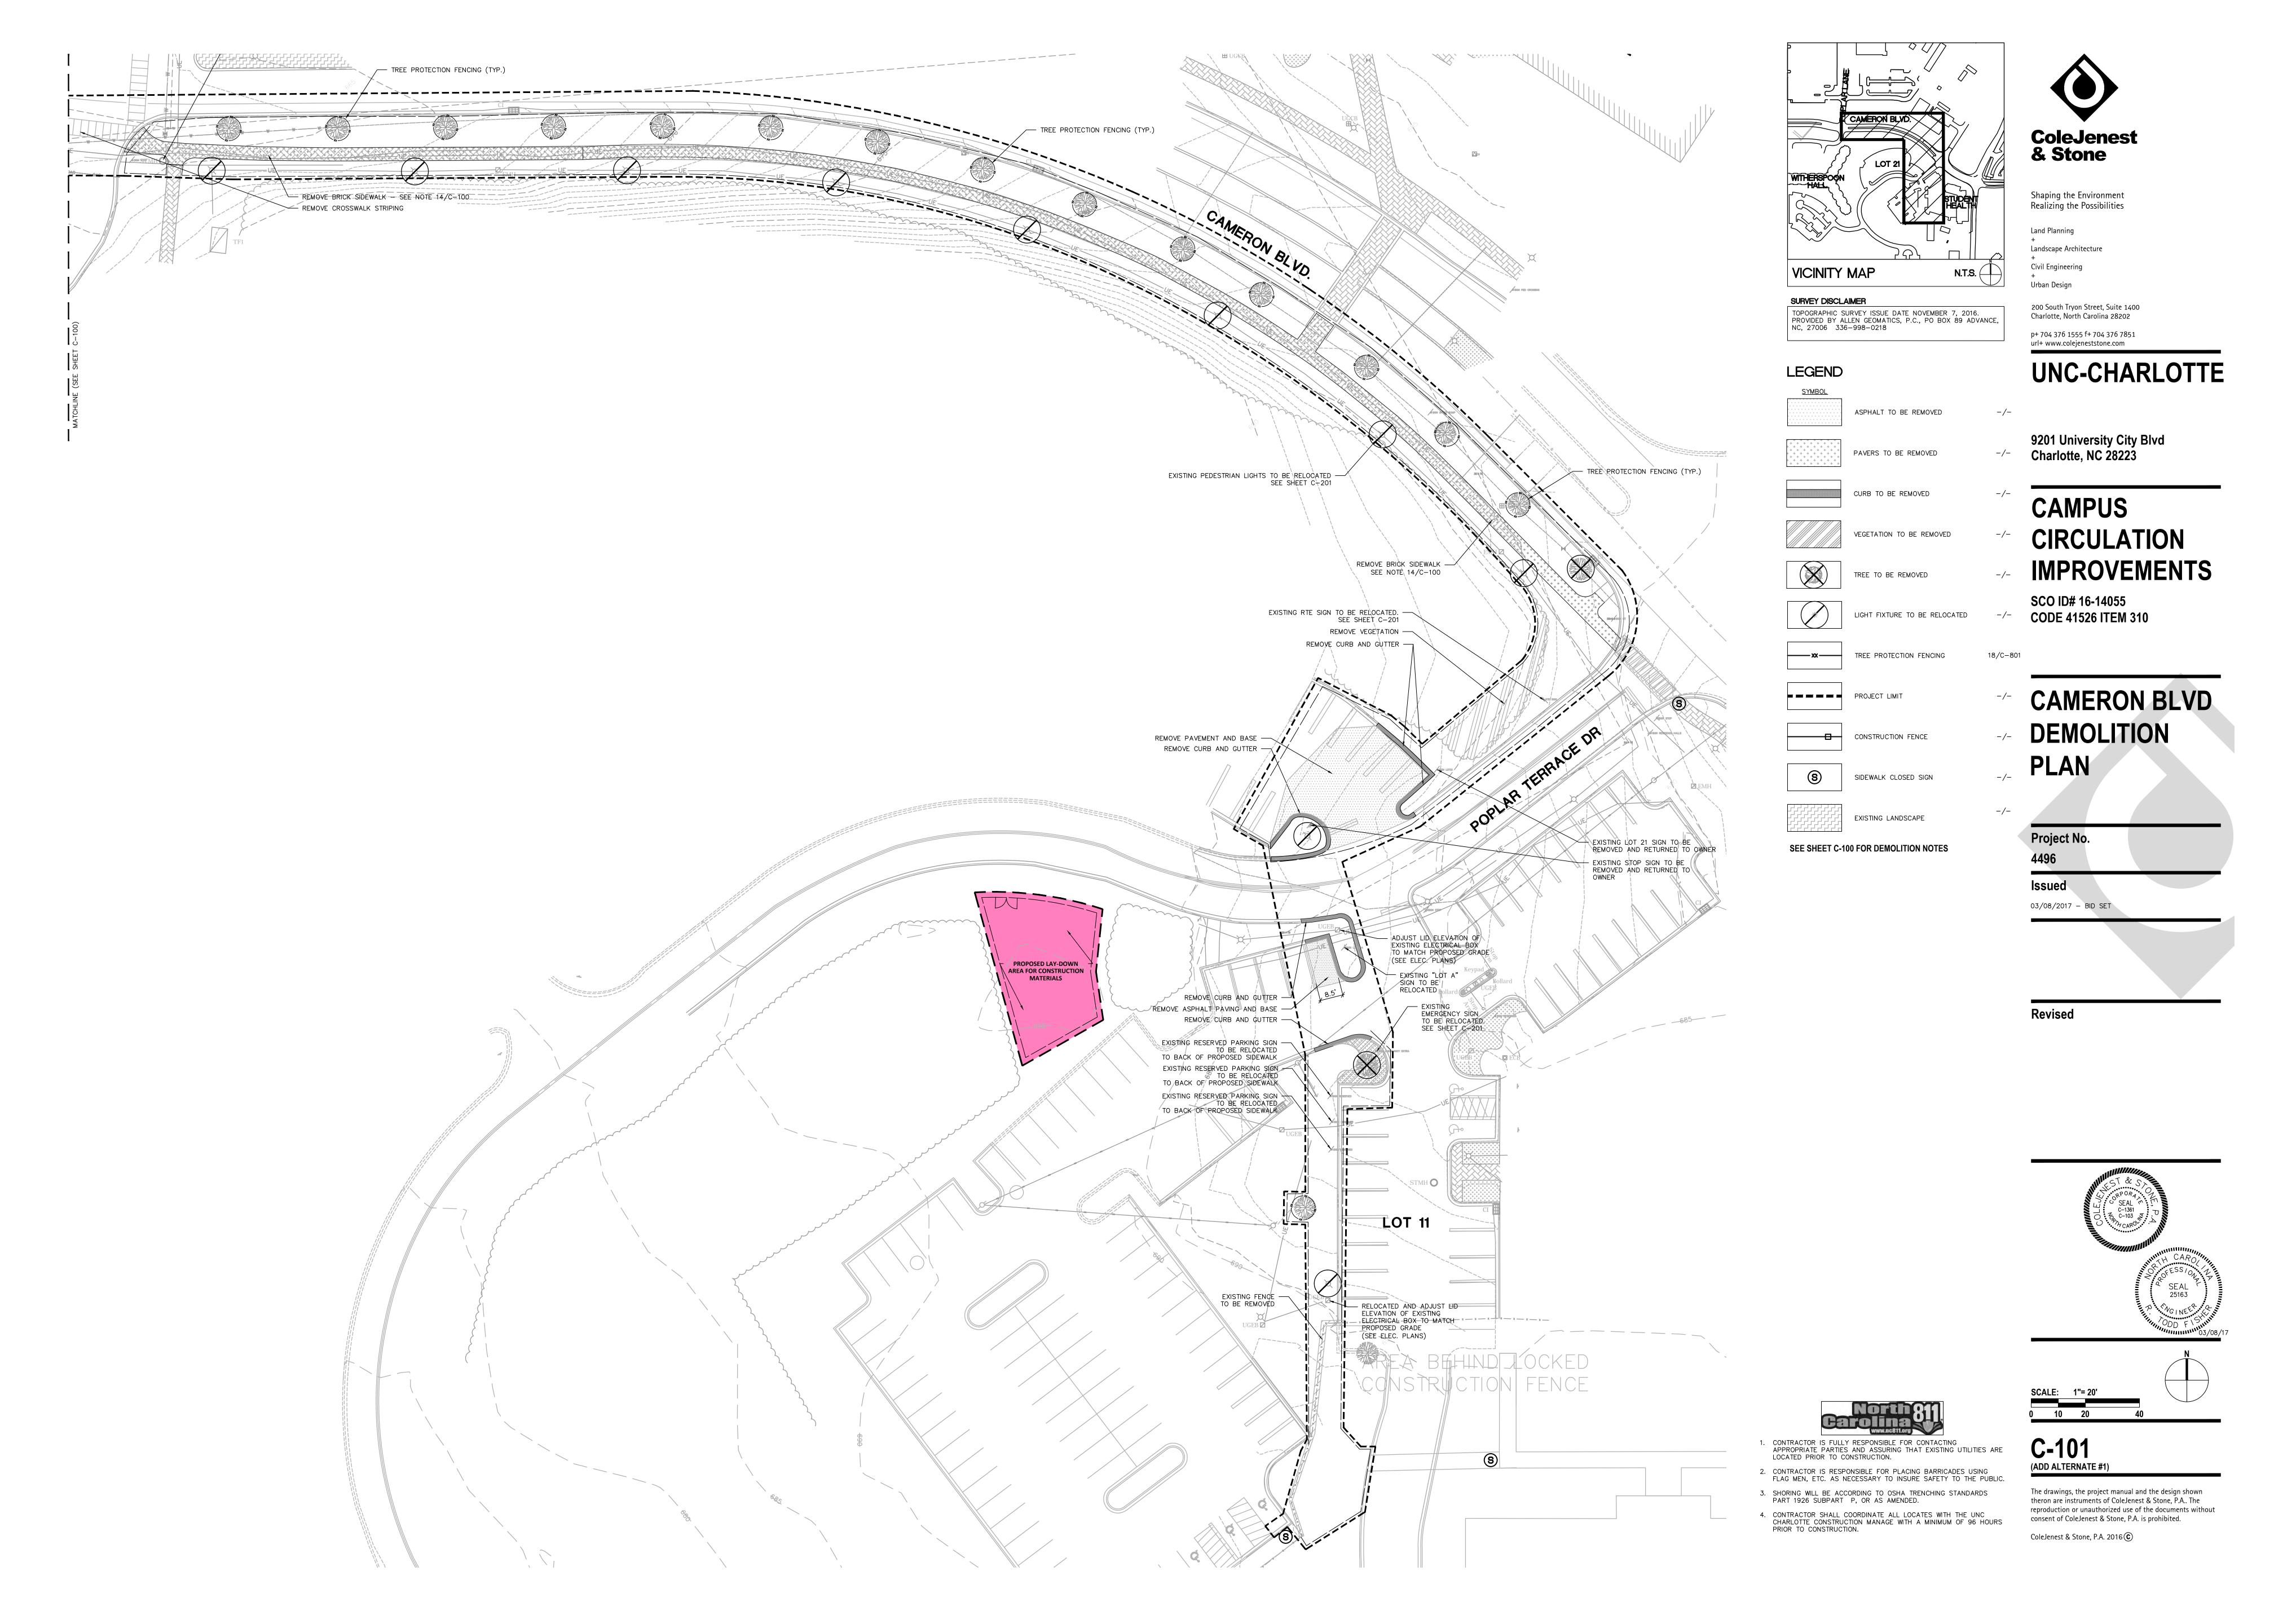CONSTRUCTION FENCE

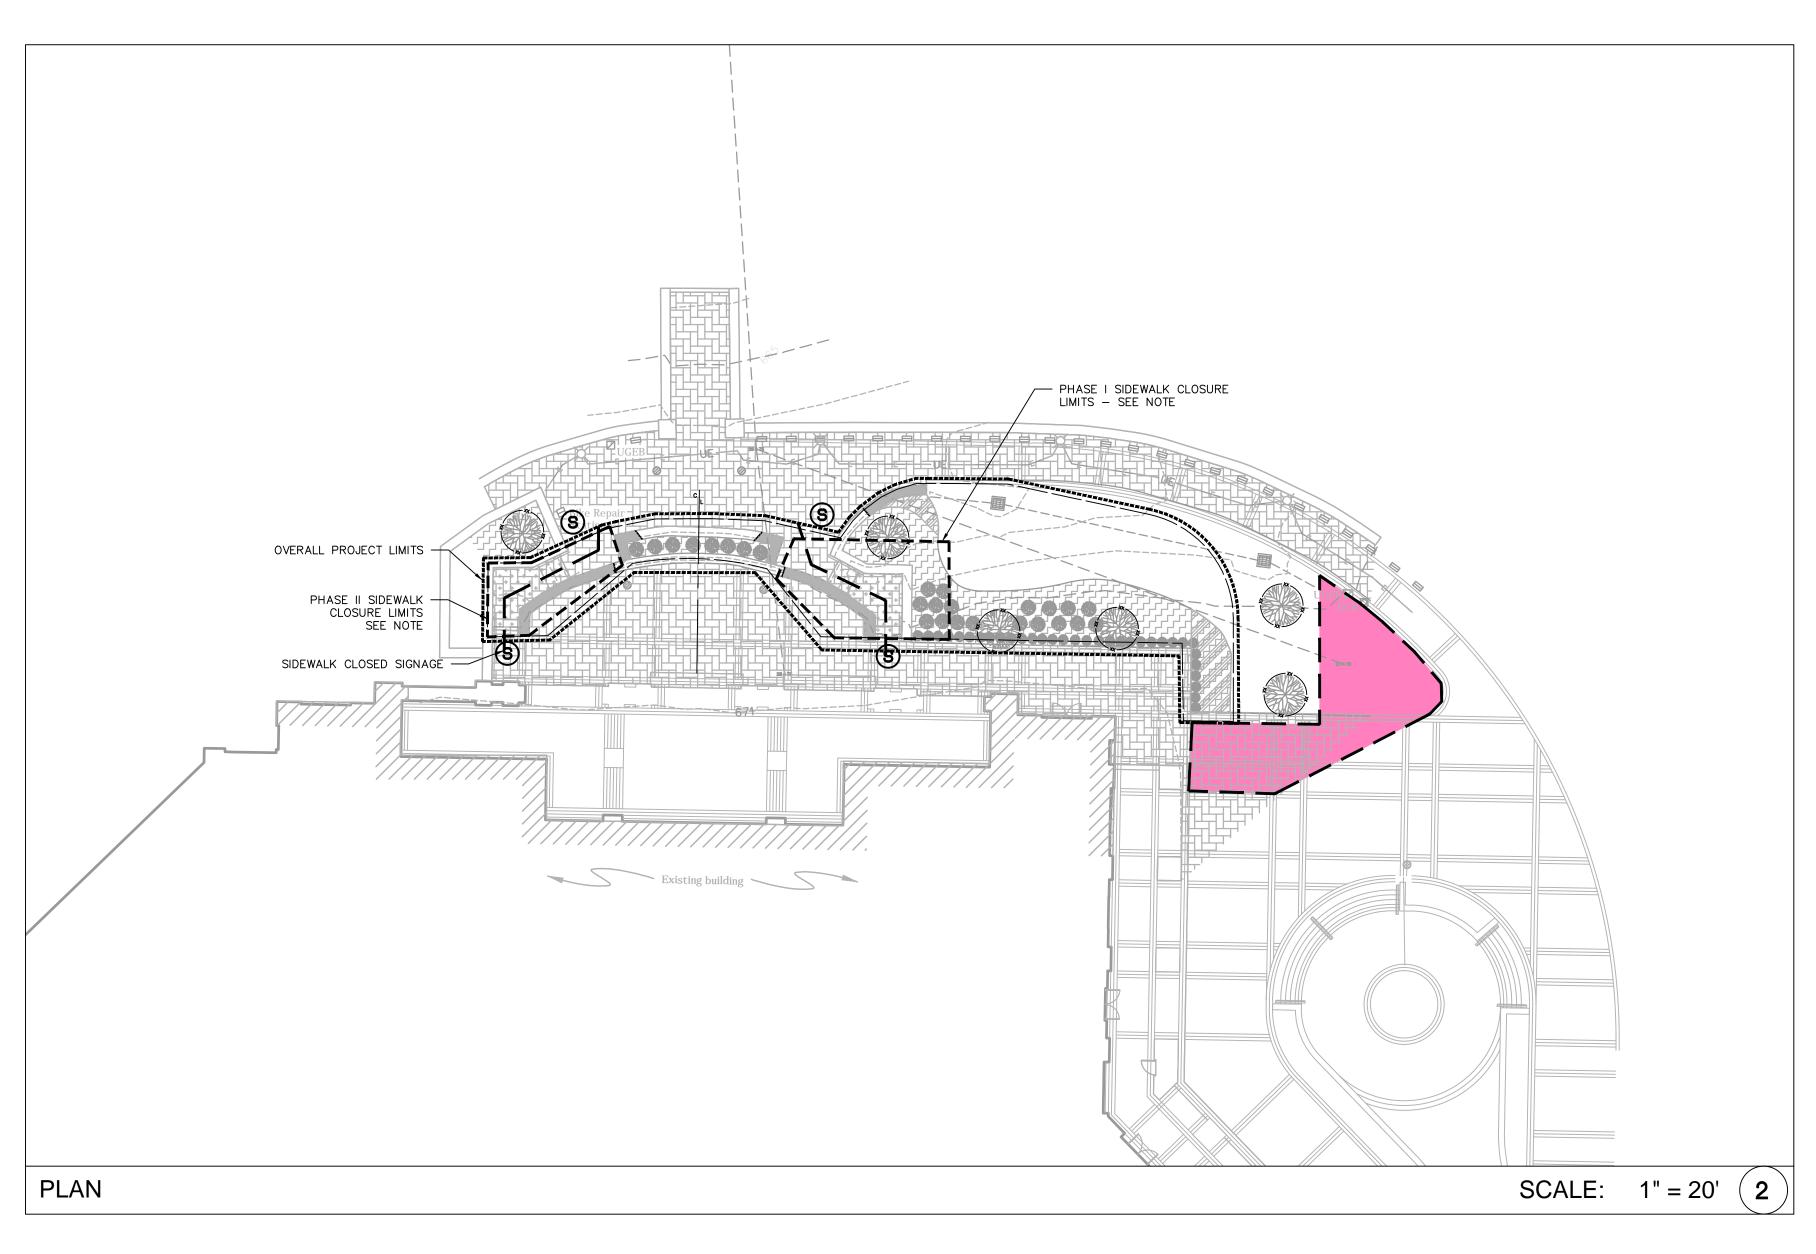SIDEWALK CLOSED SIGN

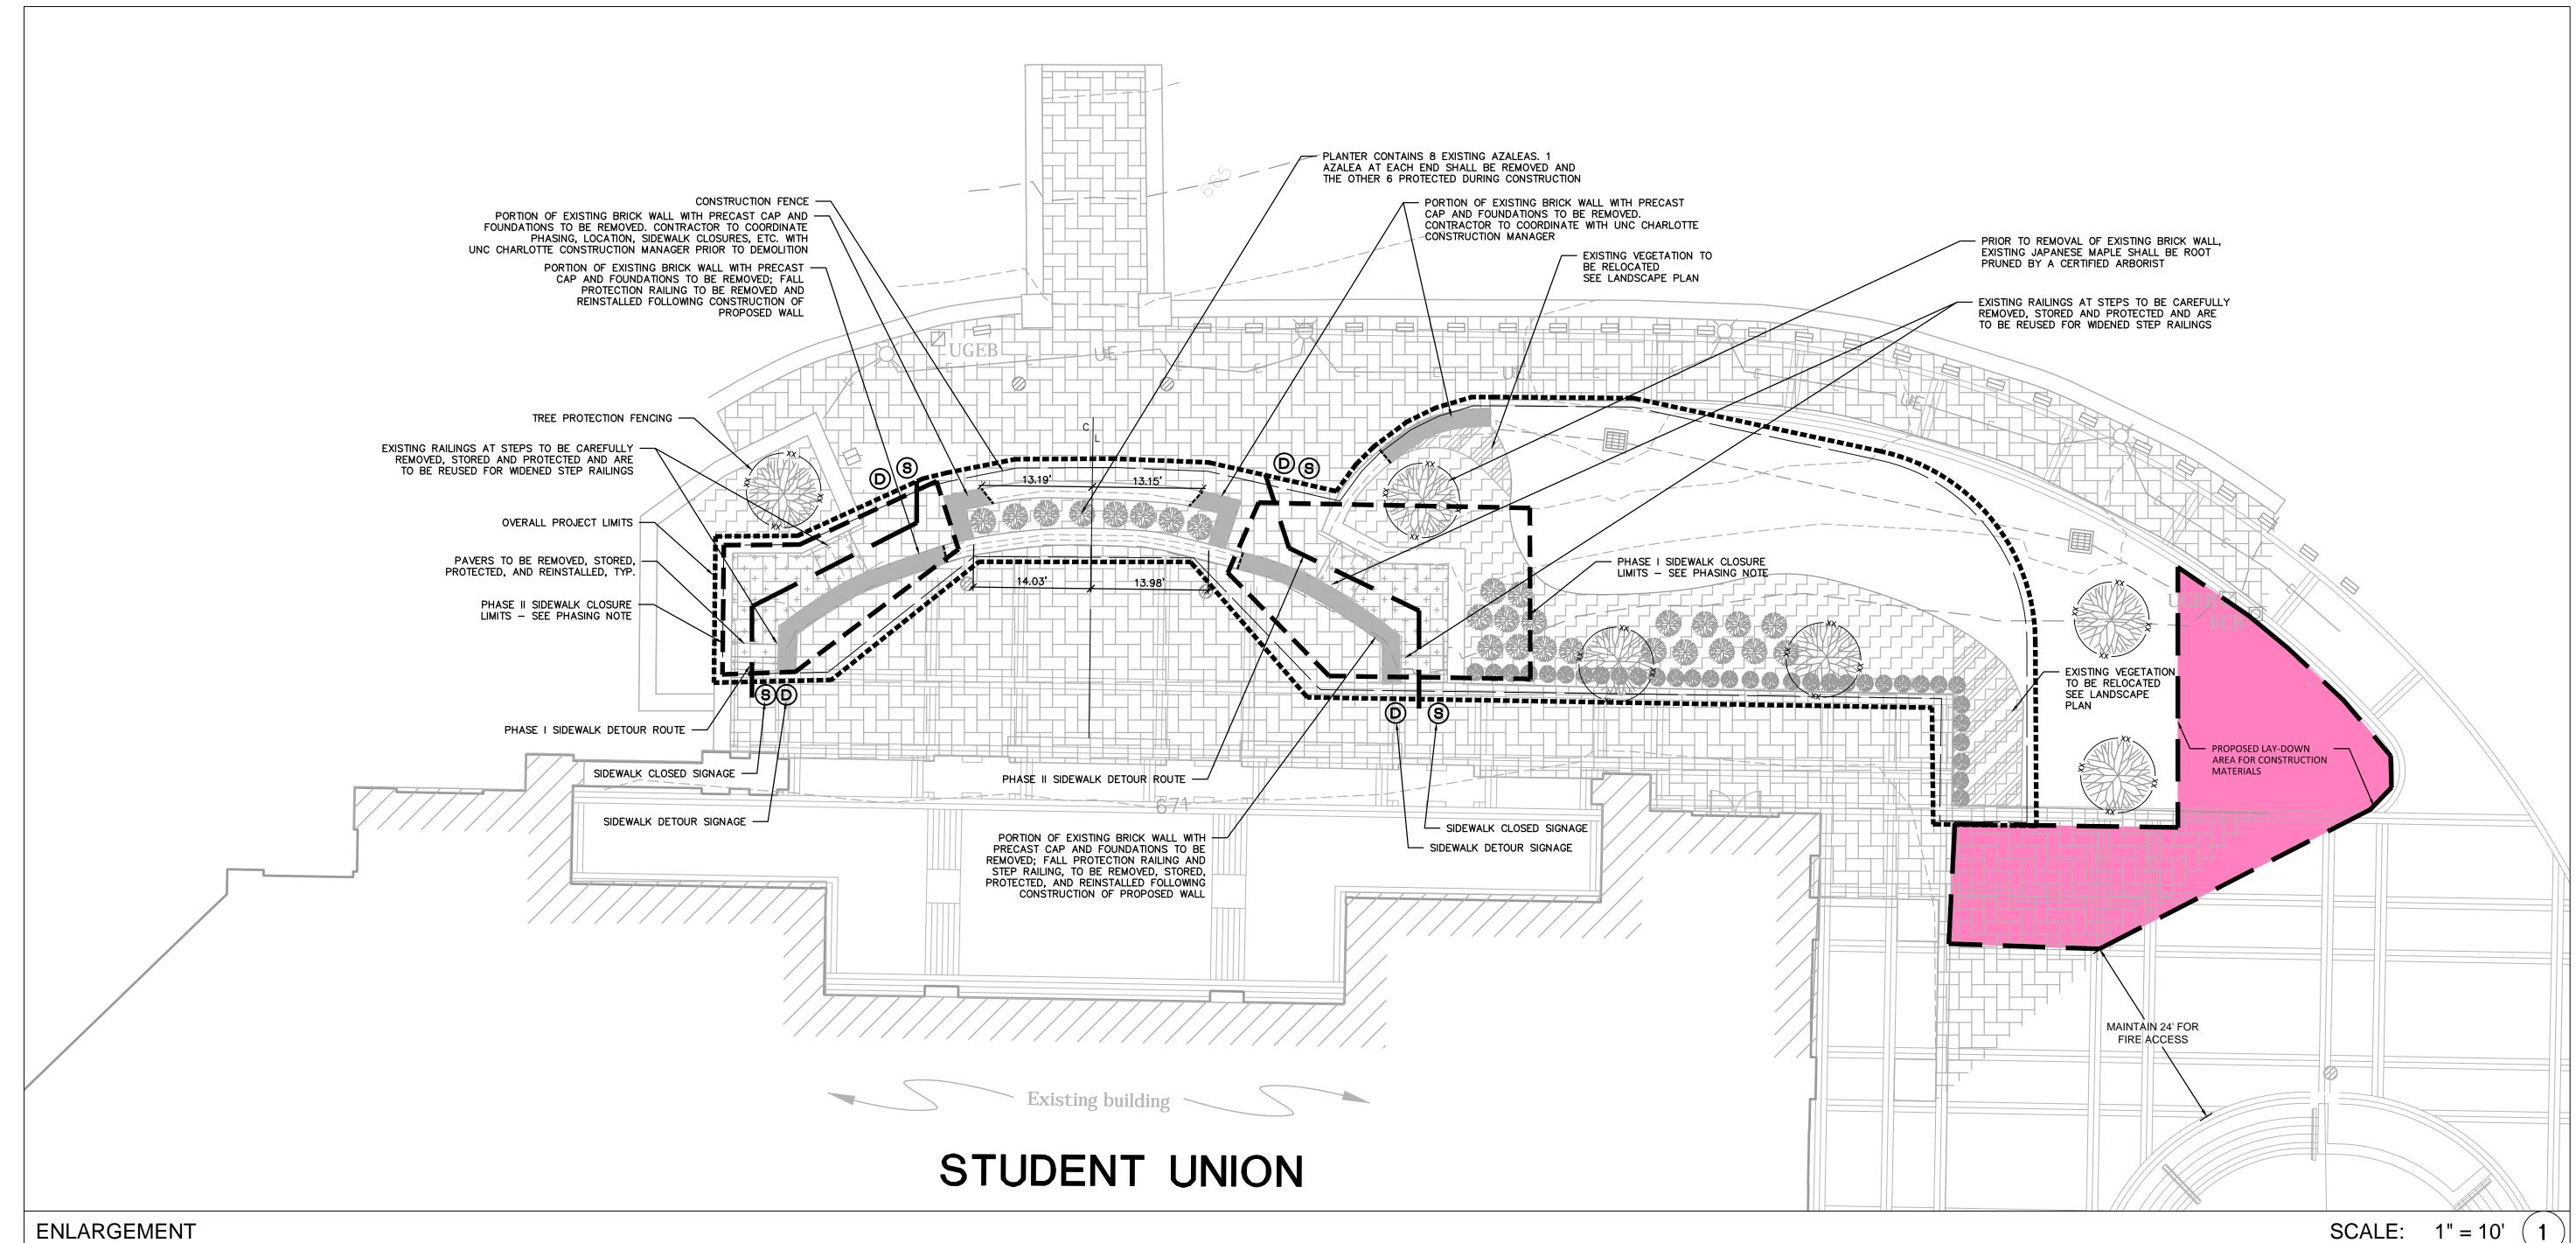SIDEWALK DETOUR SIGN

EXISTING LANDSCAPE

LEGEND

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UNC-CHARLOTTE

9201 University City Blvd Charlotte, NC 28223 WALL TO BE REMOVED

CAMPUS CIRCULATION IMPROVEMENTS

SCO ID# 16-14055 -/- **CODE 41526 ITEM 310**

> STUDENT UNION-**DEMOLITION PLAN**

SEE SHEET C-100 FOR DEMOLITION NOTES

PROJECT LIMIT


PHASING NOTES: 1. ONLY ONE SIDE OF STAIRWAY TO BE CLOSED AT ANY GIVEN TIME DURING CONSTRUCTION. REMAINING STAIR TO REMAIN OPEN TO PEDESTRIAN TRAFFIC.

2. ALL SIDEWALK CLOSURES SHALL BE ACCOMPANIED WITH A DETOUR SIGN AND ROUTE (SEE PLAN FOR DETAILS).

Issued


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Revised

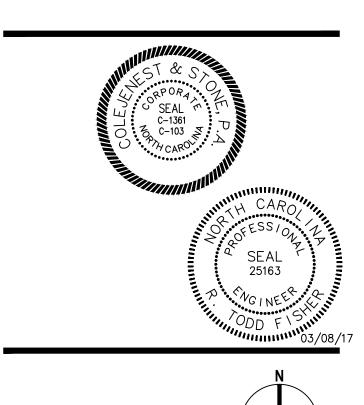

North 9


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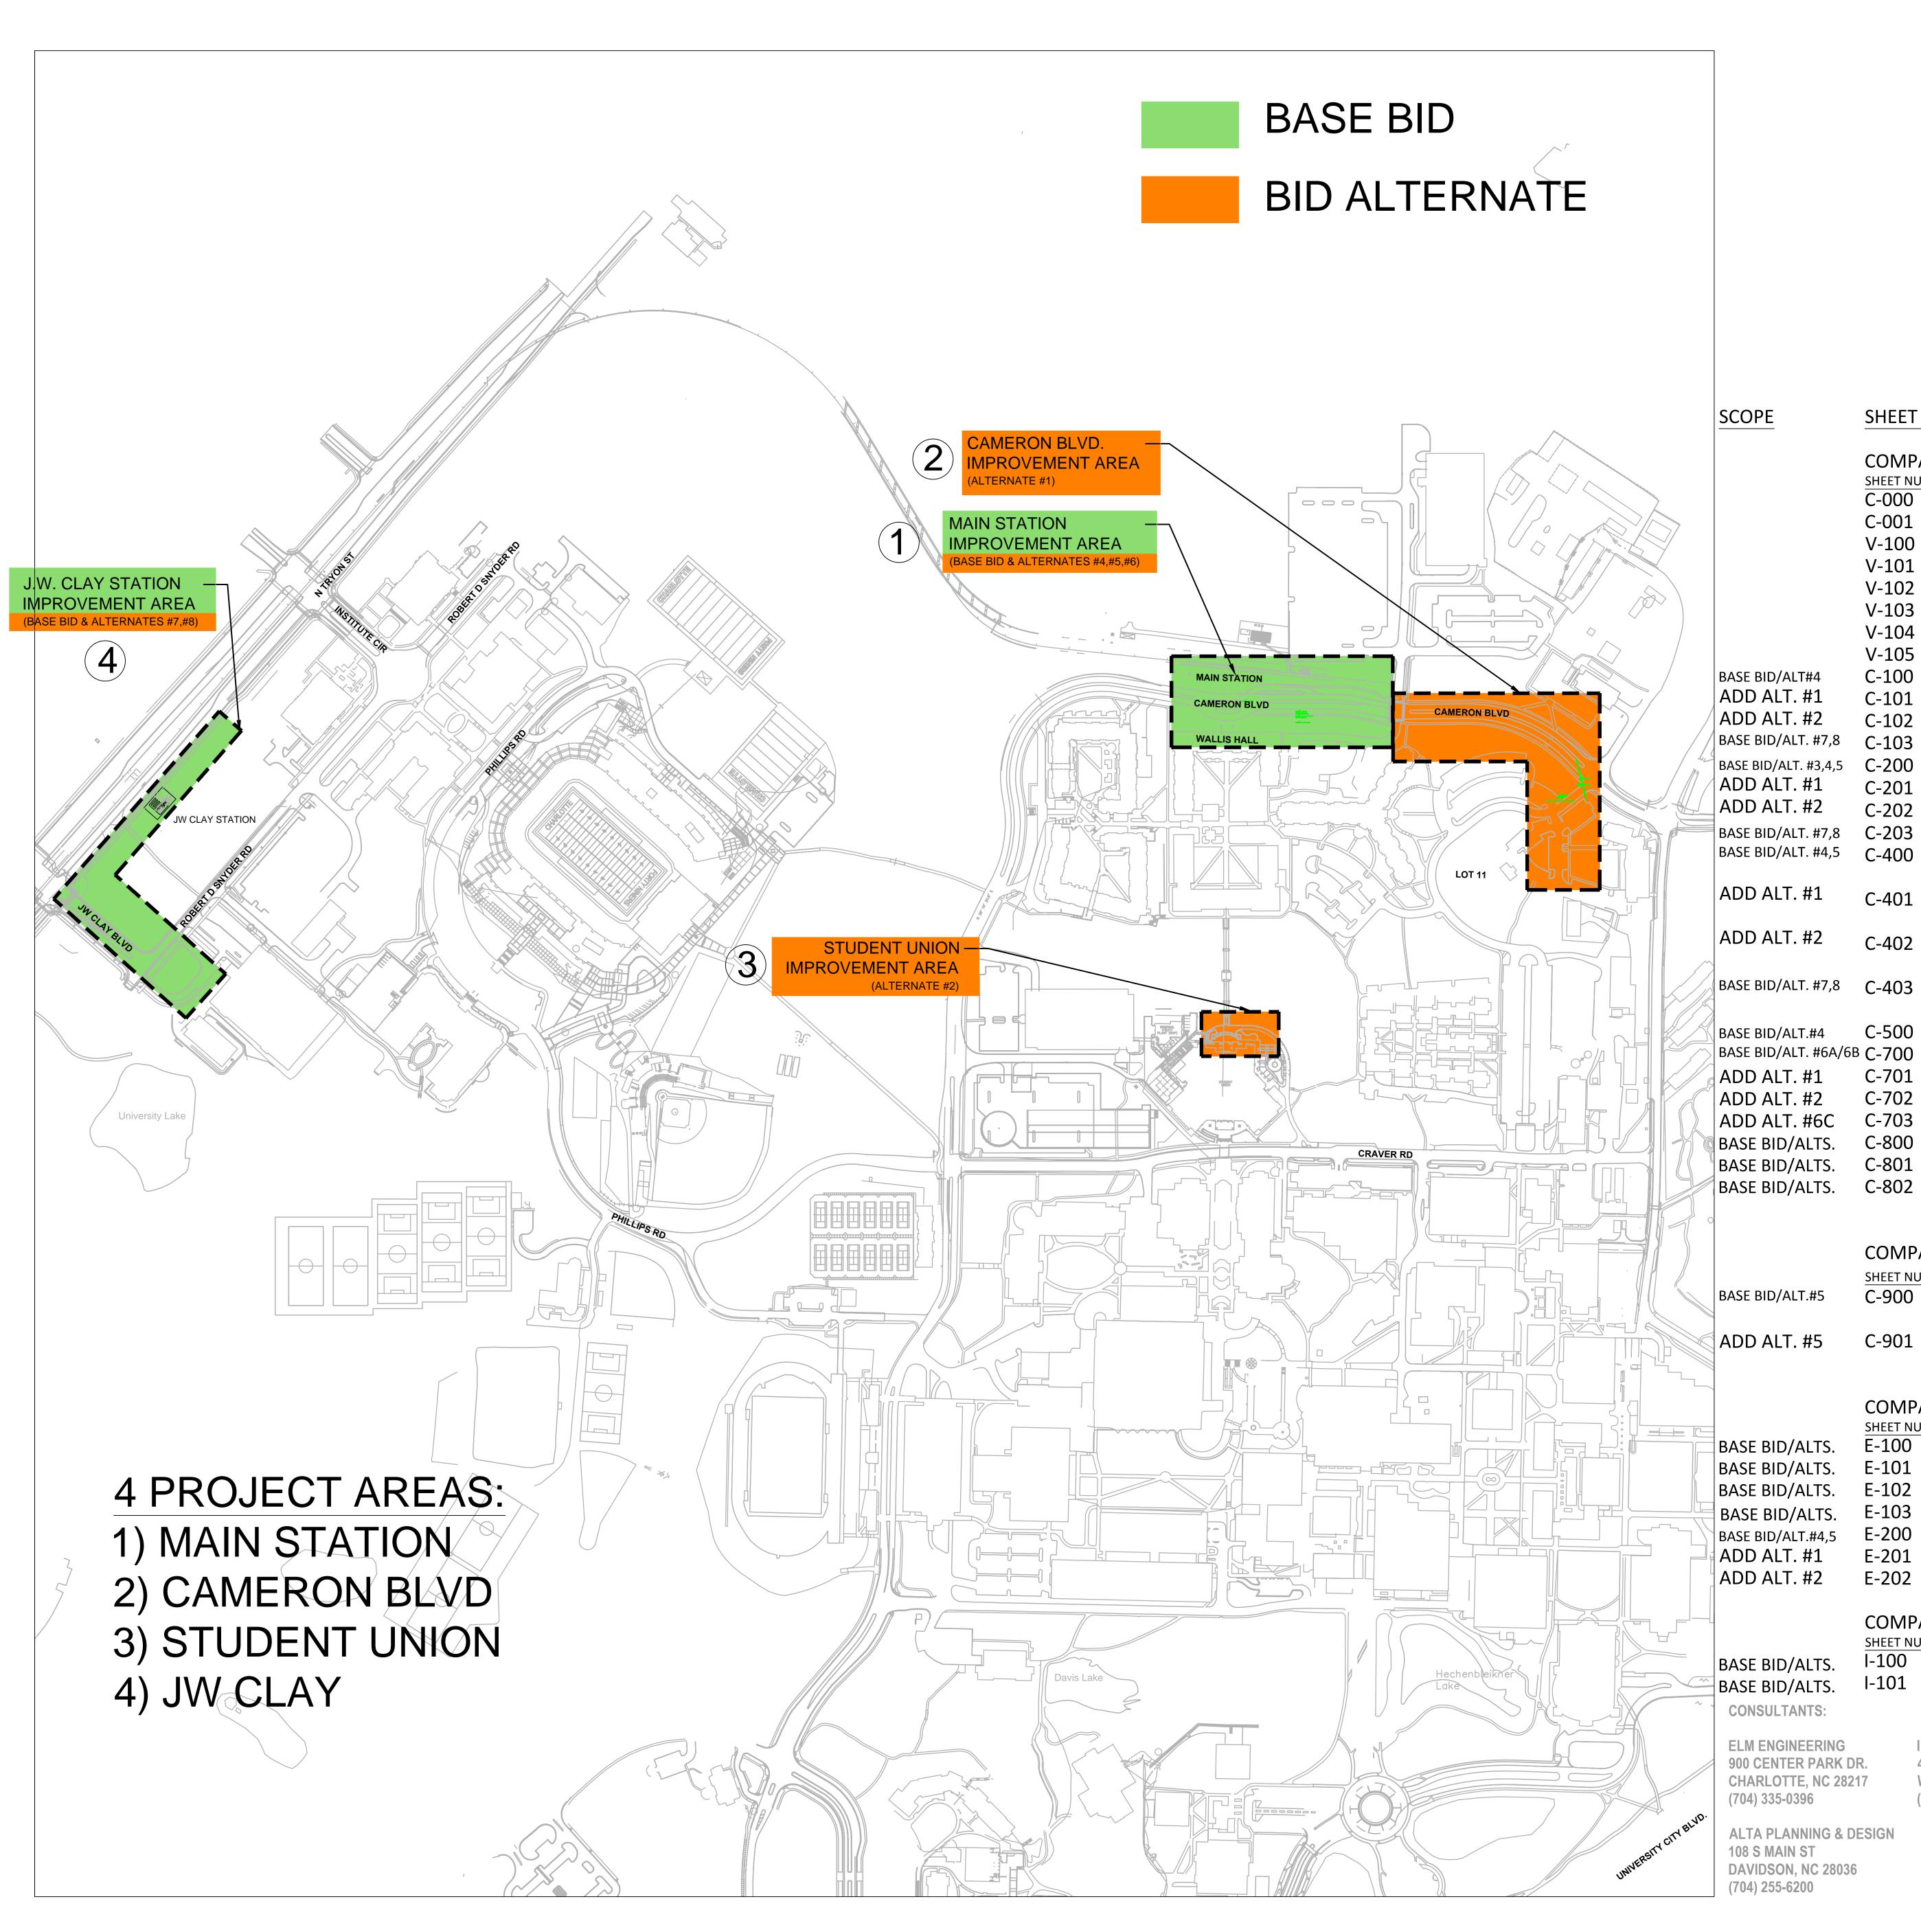



(ADD ALTERNATE #2)
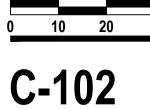
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CAMERON BLVD - EXISTING CONDITIONS

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MAIN STATION - EXISTING CONDITIONS

LOT 11 - EXISTING CONDITIONS
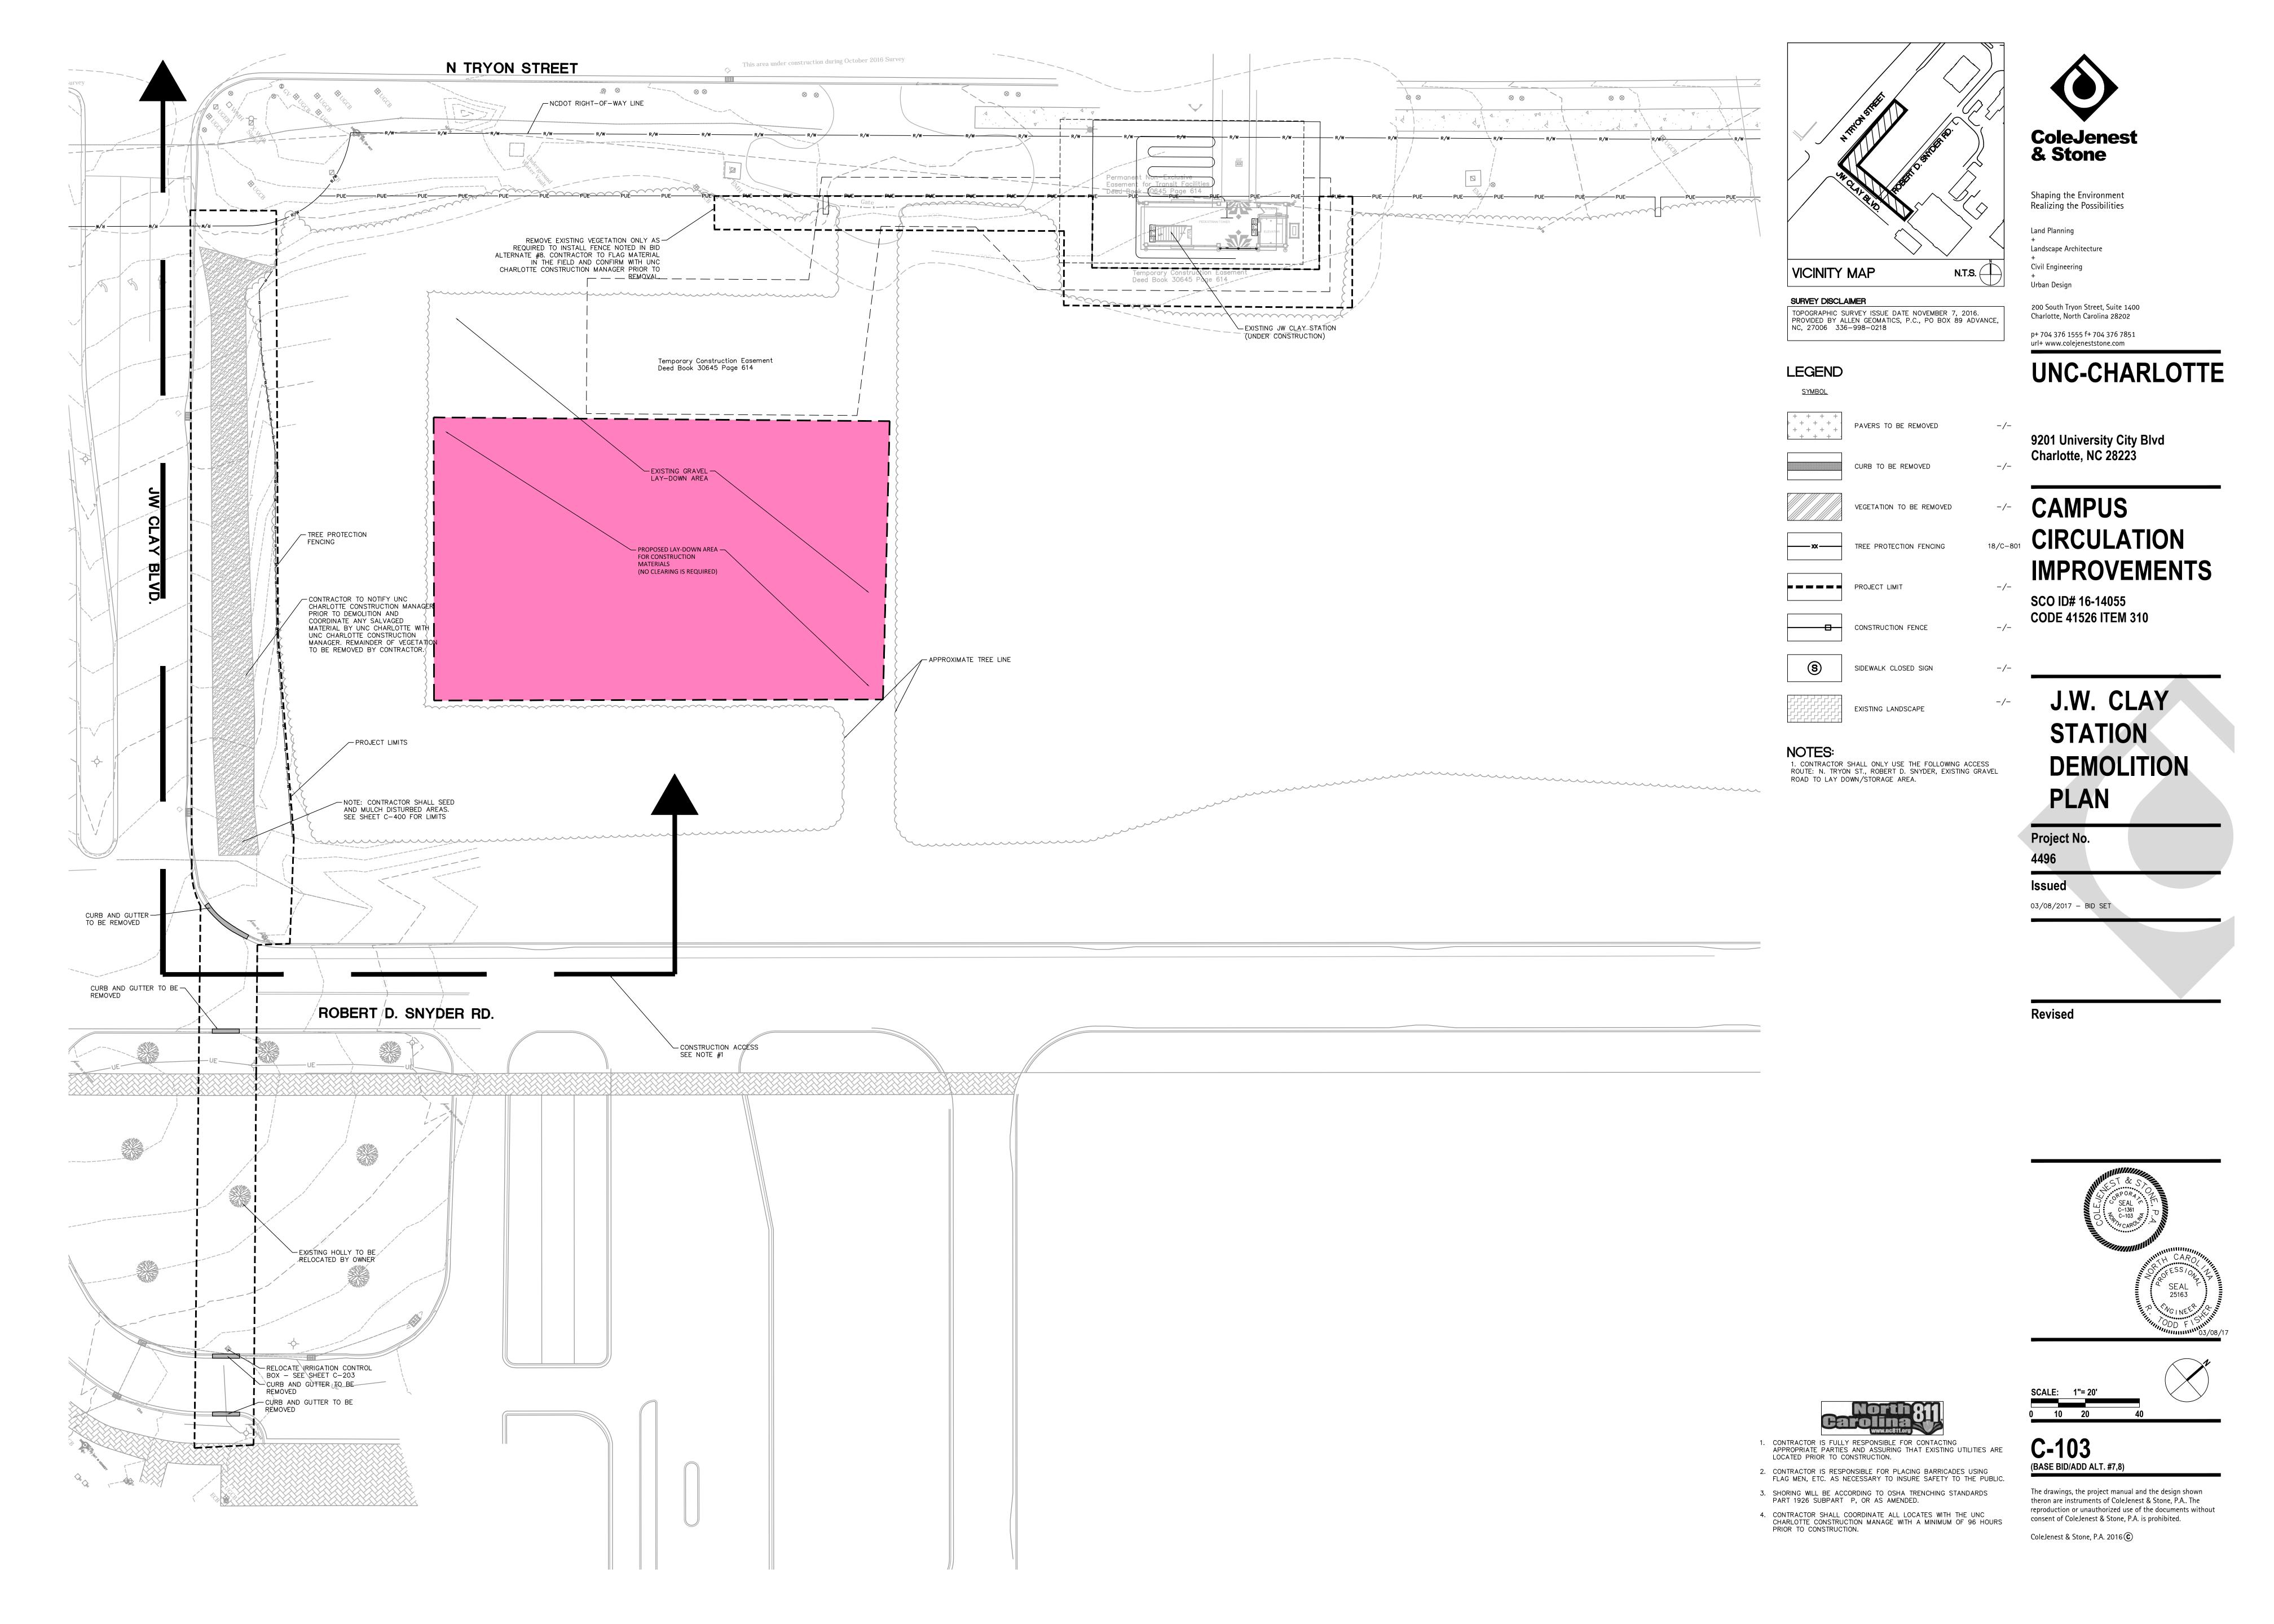
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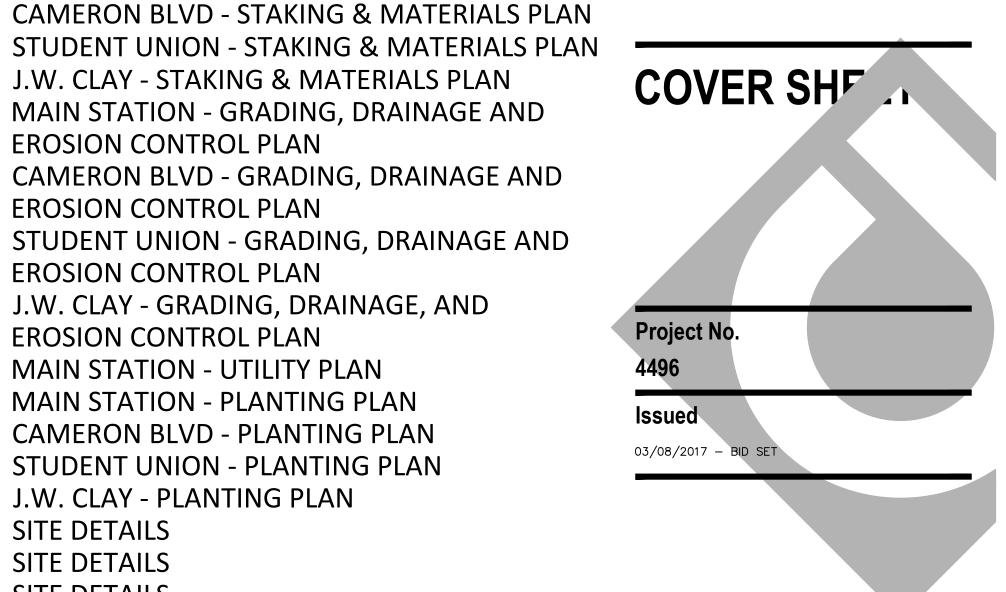
Charlotte, North Carolina 28202 p+ 704 376 1555 f+ 704 376 7851
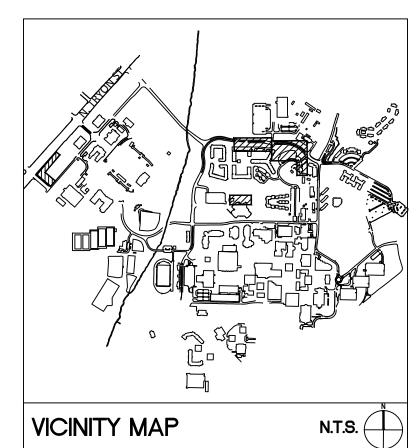
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CAMPUS CIRCULATION IMPROVEMENTS

SCO ID# 16-14055 **CODE 41526 ITEM 310**



Revised

COMPANY: ALTA PLANNING AND DESIGN

SITE DETAILS

SITE DETAILS

SITE DETAILS

SHEET NUMBER SHEET TITLE C-900

SHEET INDEX

SHEET NUMBER

C-000

C-001

V-100

V-101

V-102

V-103

V-104

V-105

C-100

C-101

C-102

C-103

C-202

C-401

C-402

C-500

C-701

C-702

C-703

C-800

C-801

C-802

COMPANY: COLE JENEST & STONE

SHEET TITLE

COVER SHEET

APPENDIX B

MAIN STATION - SIGNAGE AND PAVEMENT MARKING PLAN

C-901 **MAIN STATION - SIGNAL PLAN**

COMPANY: ELM ENGINEERING

SHEET NUMBER

ELECTRICAL COVER SHEET E-100

E-101 EXISTING ELECTRICAL POWER RISER DIAGRAM E-102 ELECTRICAL DETAILS

E-103 PANELBOARD SCHEDULE AND DETAILS

E-200 MAIN STATION - SITE PLAN E-201 CAMERON BLVD - SITE PLAN E-202 STUDENT UNION - SITE PLAN

IRRIGATION INNOVATIONS

4218 CAHNNAS WAY

WAXHAW, NC 28173

(704) 256-4873

COMPANY: IRRIGATION INNOVATIONS

SHEET NUMBER SHEET TITLE


MAIN STATION - IRRIGATION PLAN MAIN STATION - IRRIGATION DETAILS

> North 21 1. CONTRACTOR IS FULLY RESPONSIBLE FOR CONTACTING APPROPRIATE PARTIES AND ASSURING THAT EXISTING UTILITIES ARE

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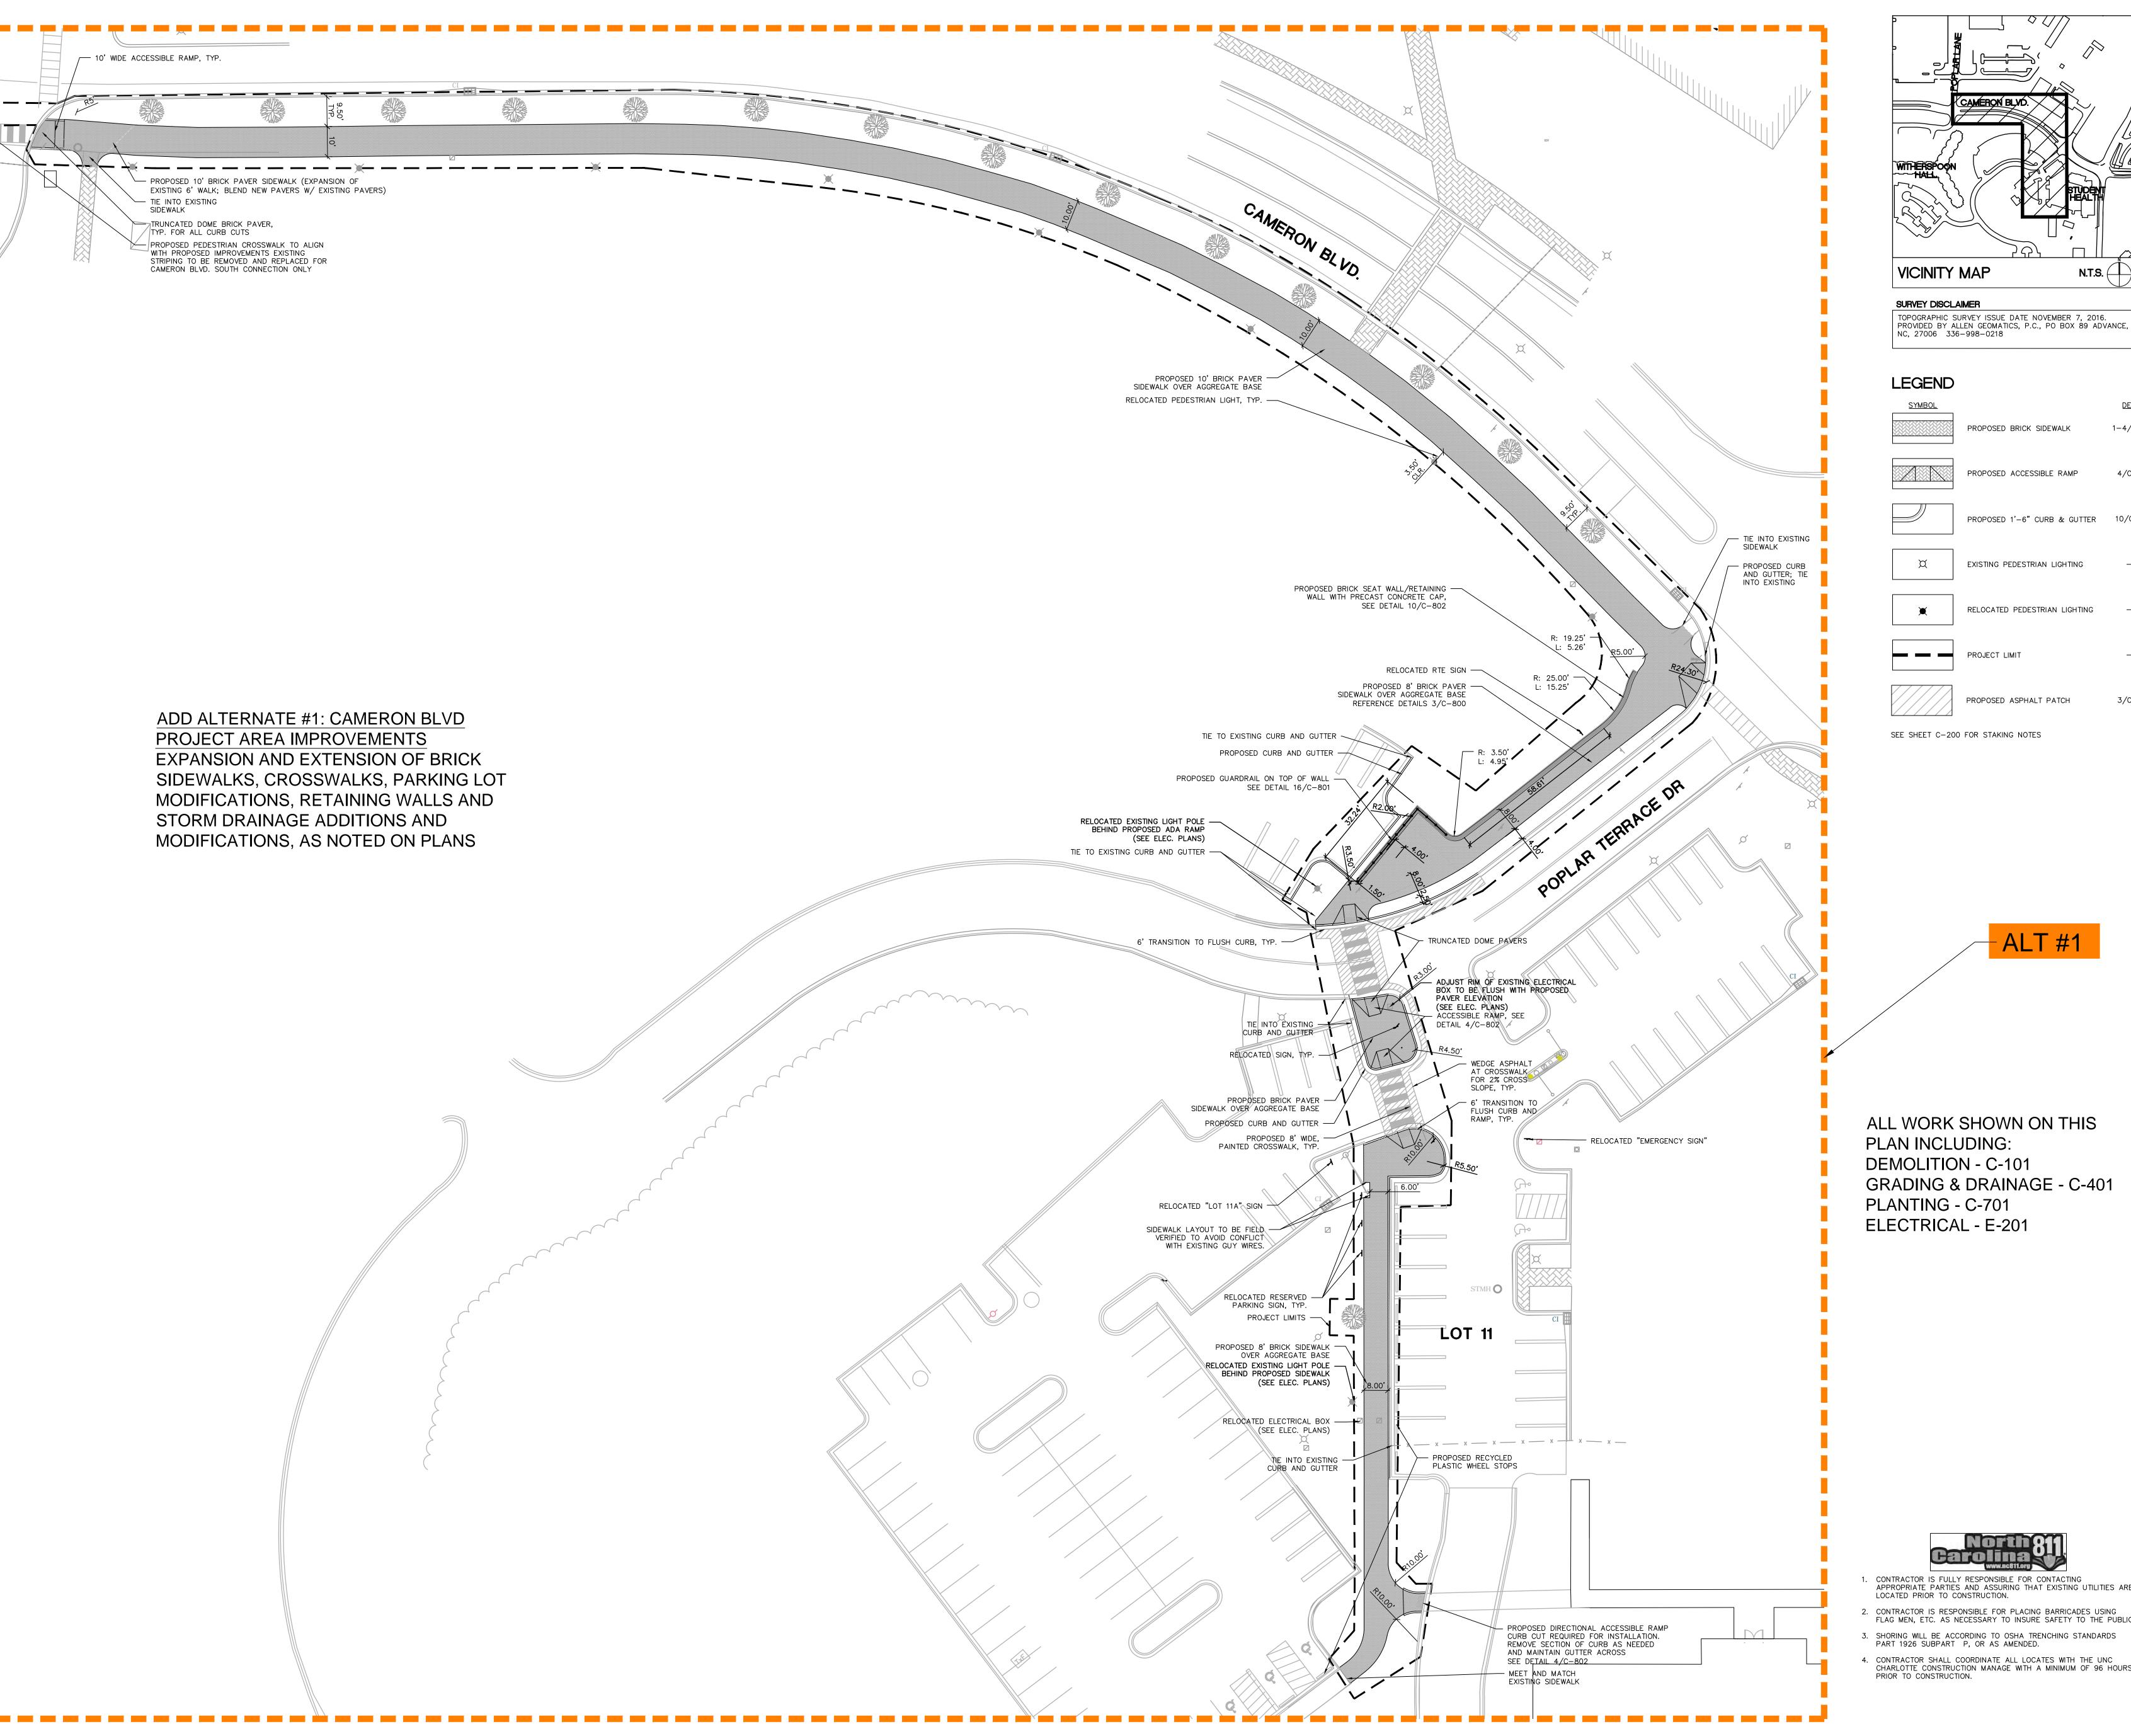
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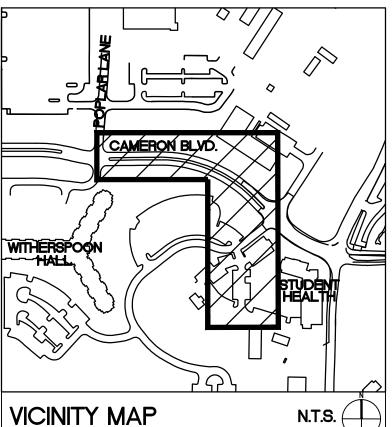
PRIOR TO CONSTRUCTION.



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PROPOSED BRICK SIDEWALK 1-4/C-800 PROPOSED ACCESSIBLE RAMP PROPOSED 1'-6" CURB & GUTTER 10/C-800 EXISTING PEDESTRIAN LIGHTING

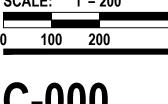RELOCATED PEDESTRIAN LIGHTING

PROPOSED ASPHALT PATCH

PROJECT LIMIT

4/C-802 Charlotte, NC 28223 **CAMPUS** CIRCULATION

IMPROVEMENTS

9201 University City Blvd

UNC-CHARLOTTE

SCO ID# 16-14055 **CODE 41526 ITEM 310**

SEE SHEET C-200 FOR STAKING NOTES

CAMERON BLVD - STAKING AND MATERIALS PLAN


Project No.

Issued

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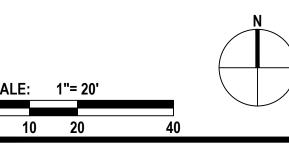
ALL WORK SHOWN ON THIS PLAN INCLUDING: DEMOLITION - C-101 **GRADING & DRAINAGE - C-401** PLANTING - C-701 ELECTRICAL - E-201



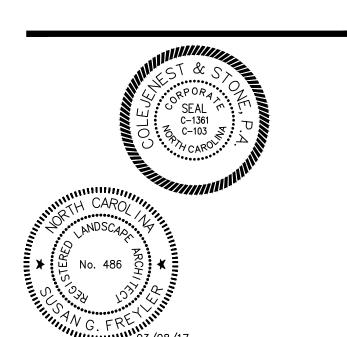


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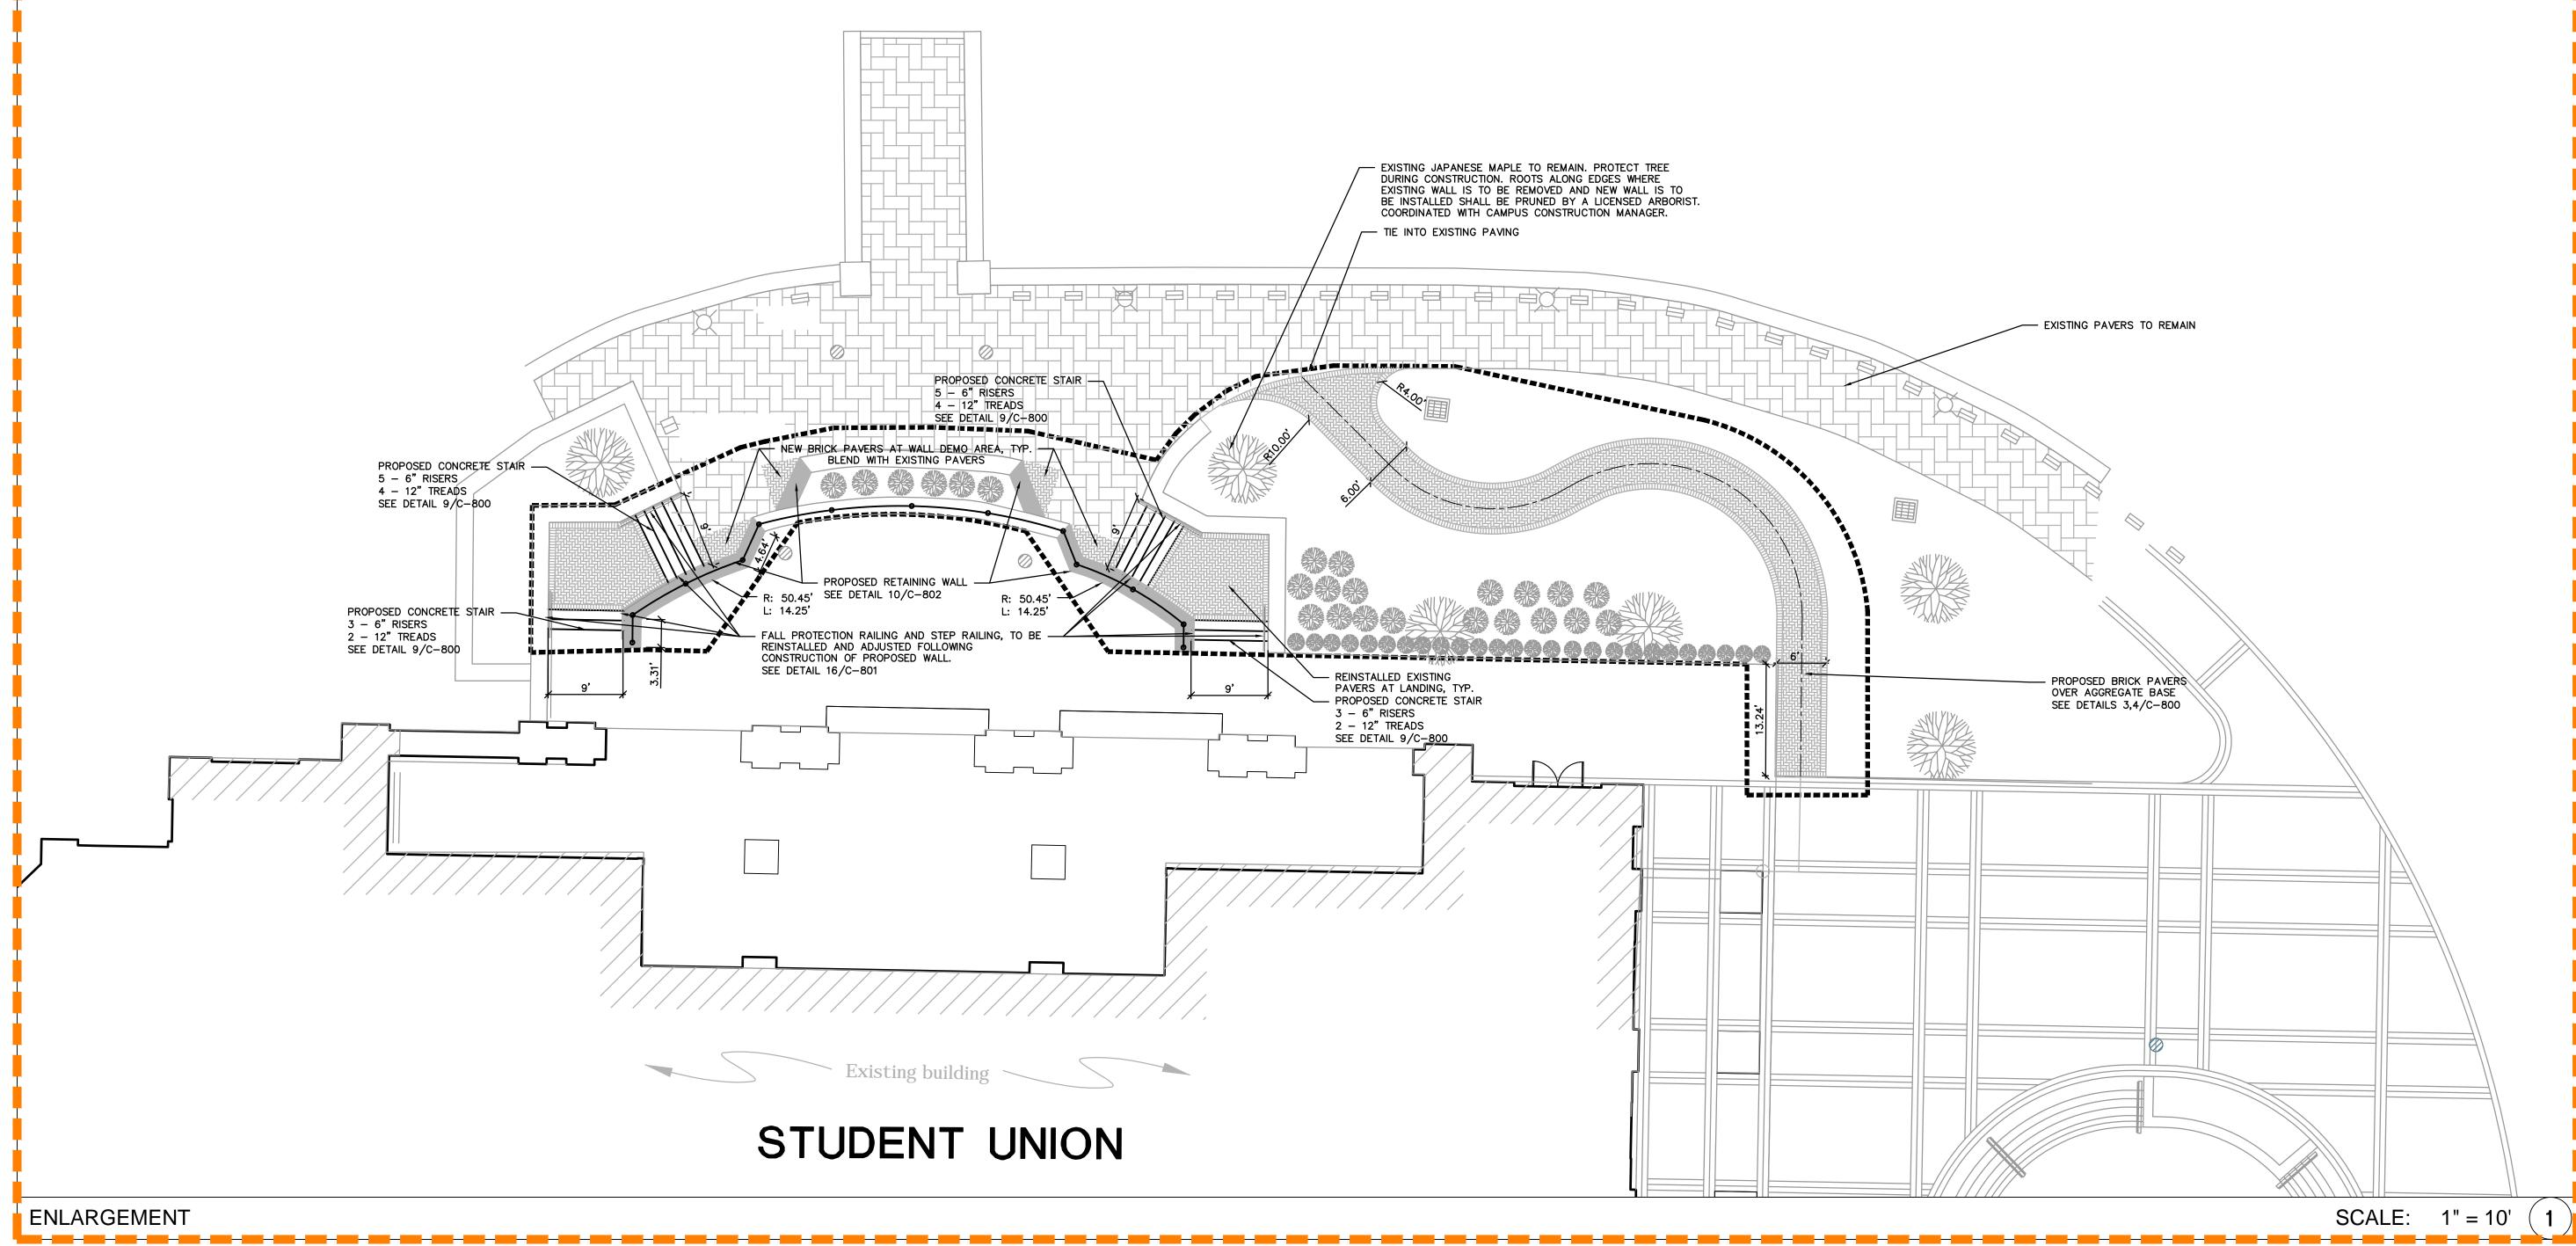



(ADD ALTERNATE #1)

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ADD ALTERNATE #2: STUDENT UNION PROJECT AREA IMPROVEMENTS
EXPANSION AND EXTENSION OF BRICK SIDEWALKS, STAIRS, RETAINING WALLS AND RAILINGS AS NOTED ON PLANS



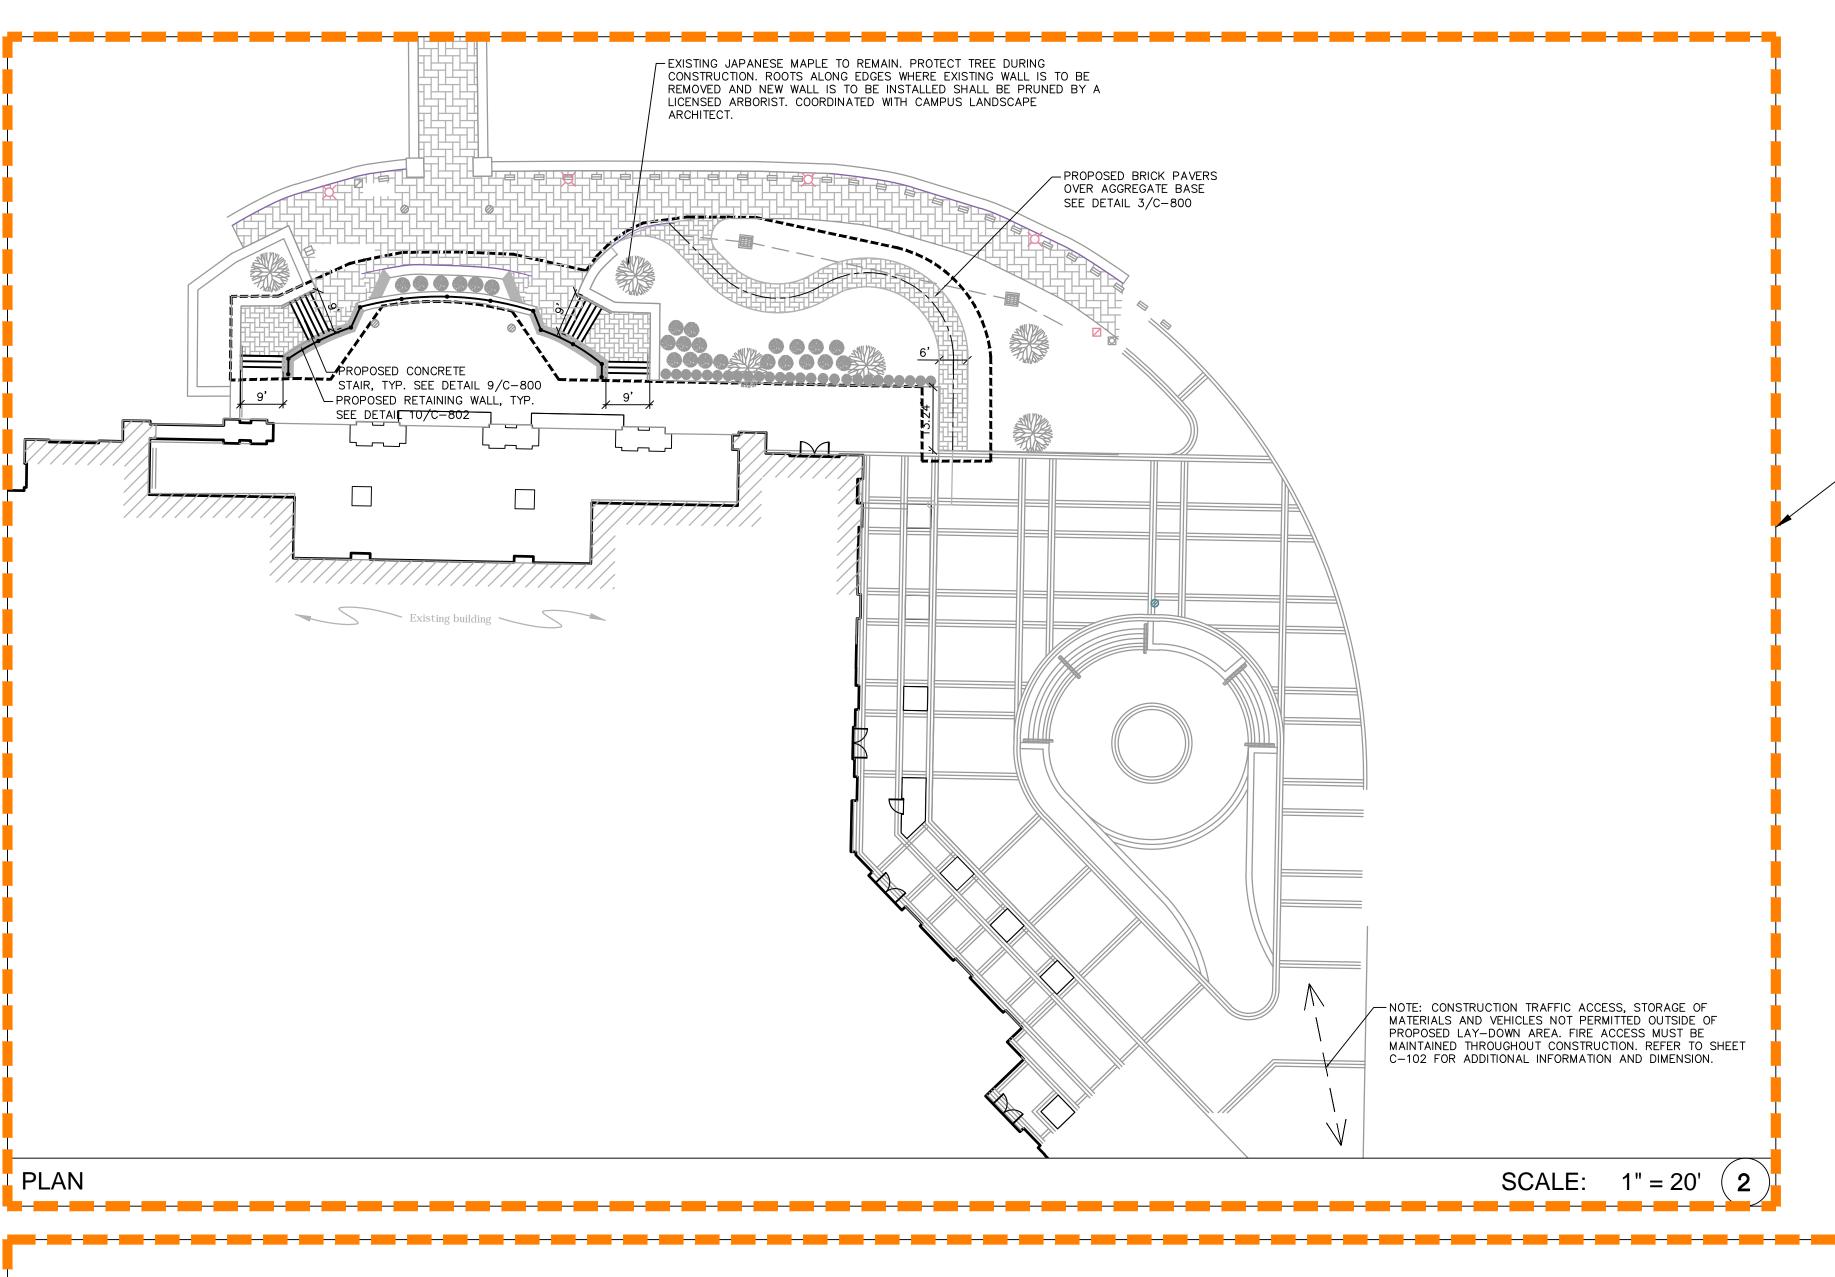

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LEGEND SYMBOL

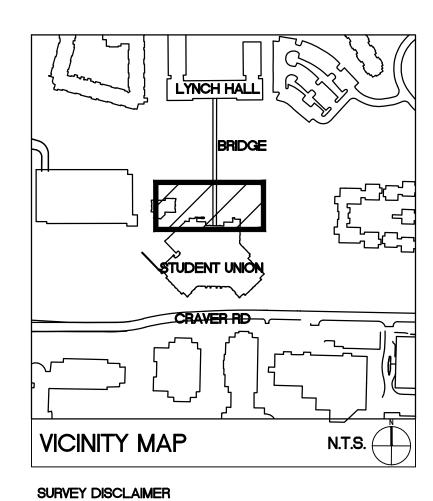SEE SHEET C-200 FOR STAKING NOTES

PROPOSED BRICK SIDEWALK

EXISTING BRICK SIDEWALK

PROPOSED LIGHTING

PROJECT LIMIT

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DETAIL 1-4/C-800

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CAMPUS CIRCULATION IMPROVEMENTS

SCO ID# 16-14055 CODE 41526 ITEM 310

STUDENT UNION - STAKING AND MATERIALS PLAN


Project No 4496

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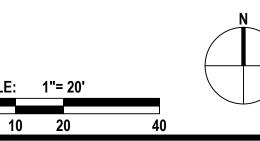
ADD ALTERNATE #2:
ALL WORK SHOWN ON THIS PLAN INCLUDING:
DEMOLITION - C-102
GRADING & DRAINAGE - C-402
PLANTING - L-702
ELECTRICAL - E-202

Revised



North 811 Carolina www.nc811.org

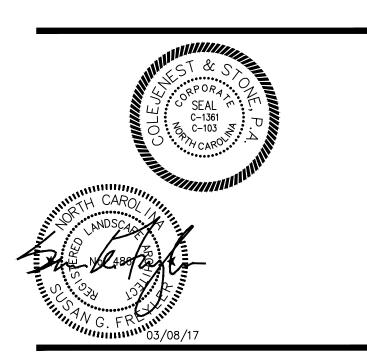
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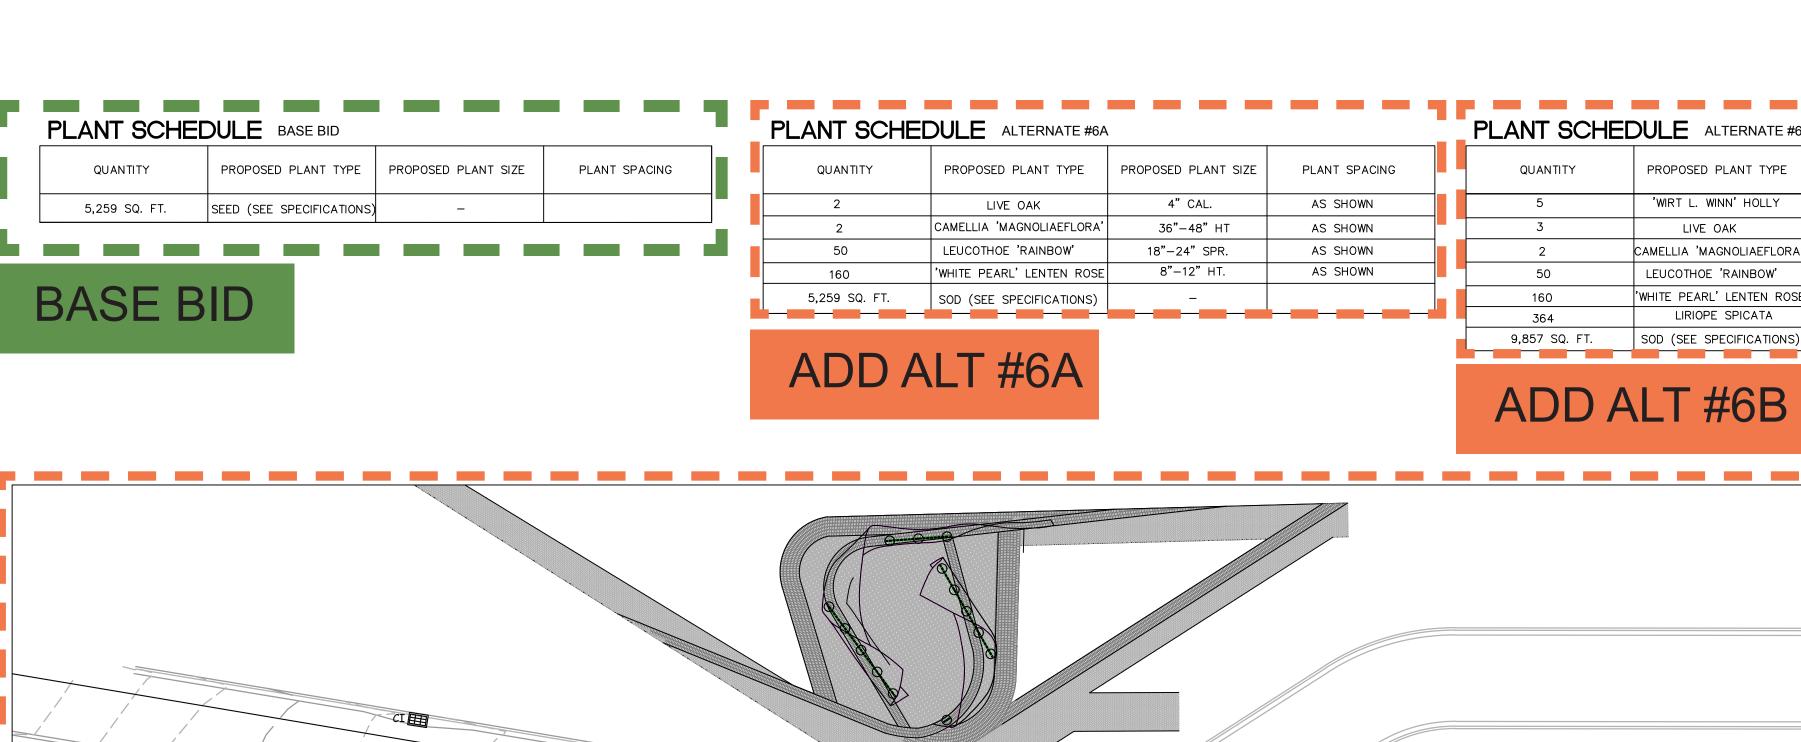


C-202
(ADD ALTERNATE #2)

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WALLIS HALL

BID ALT. 6A

EXISTING TREE TO REMAIN —

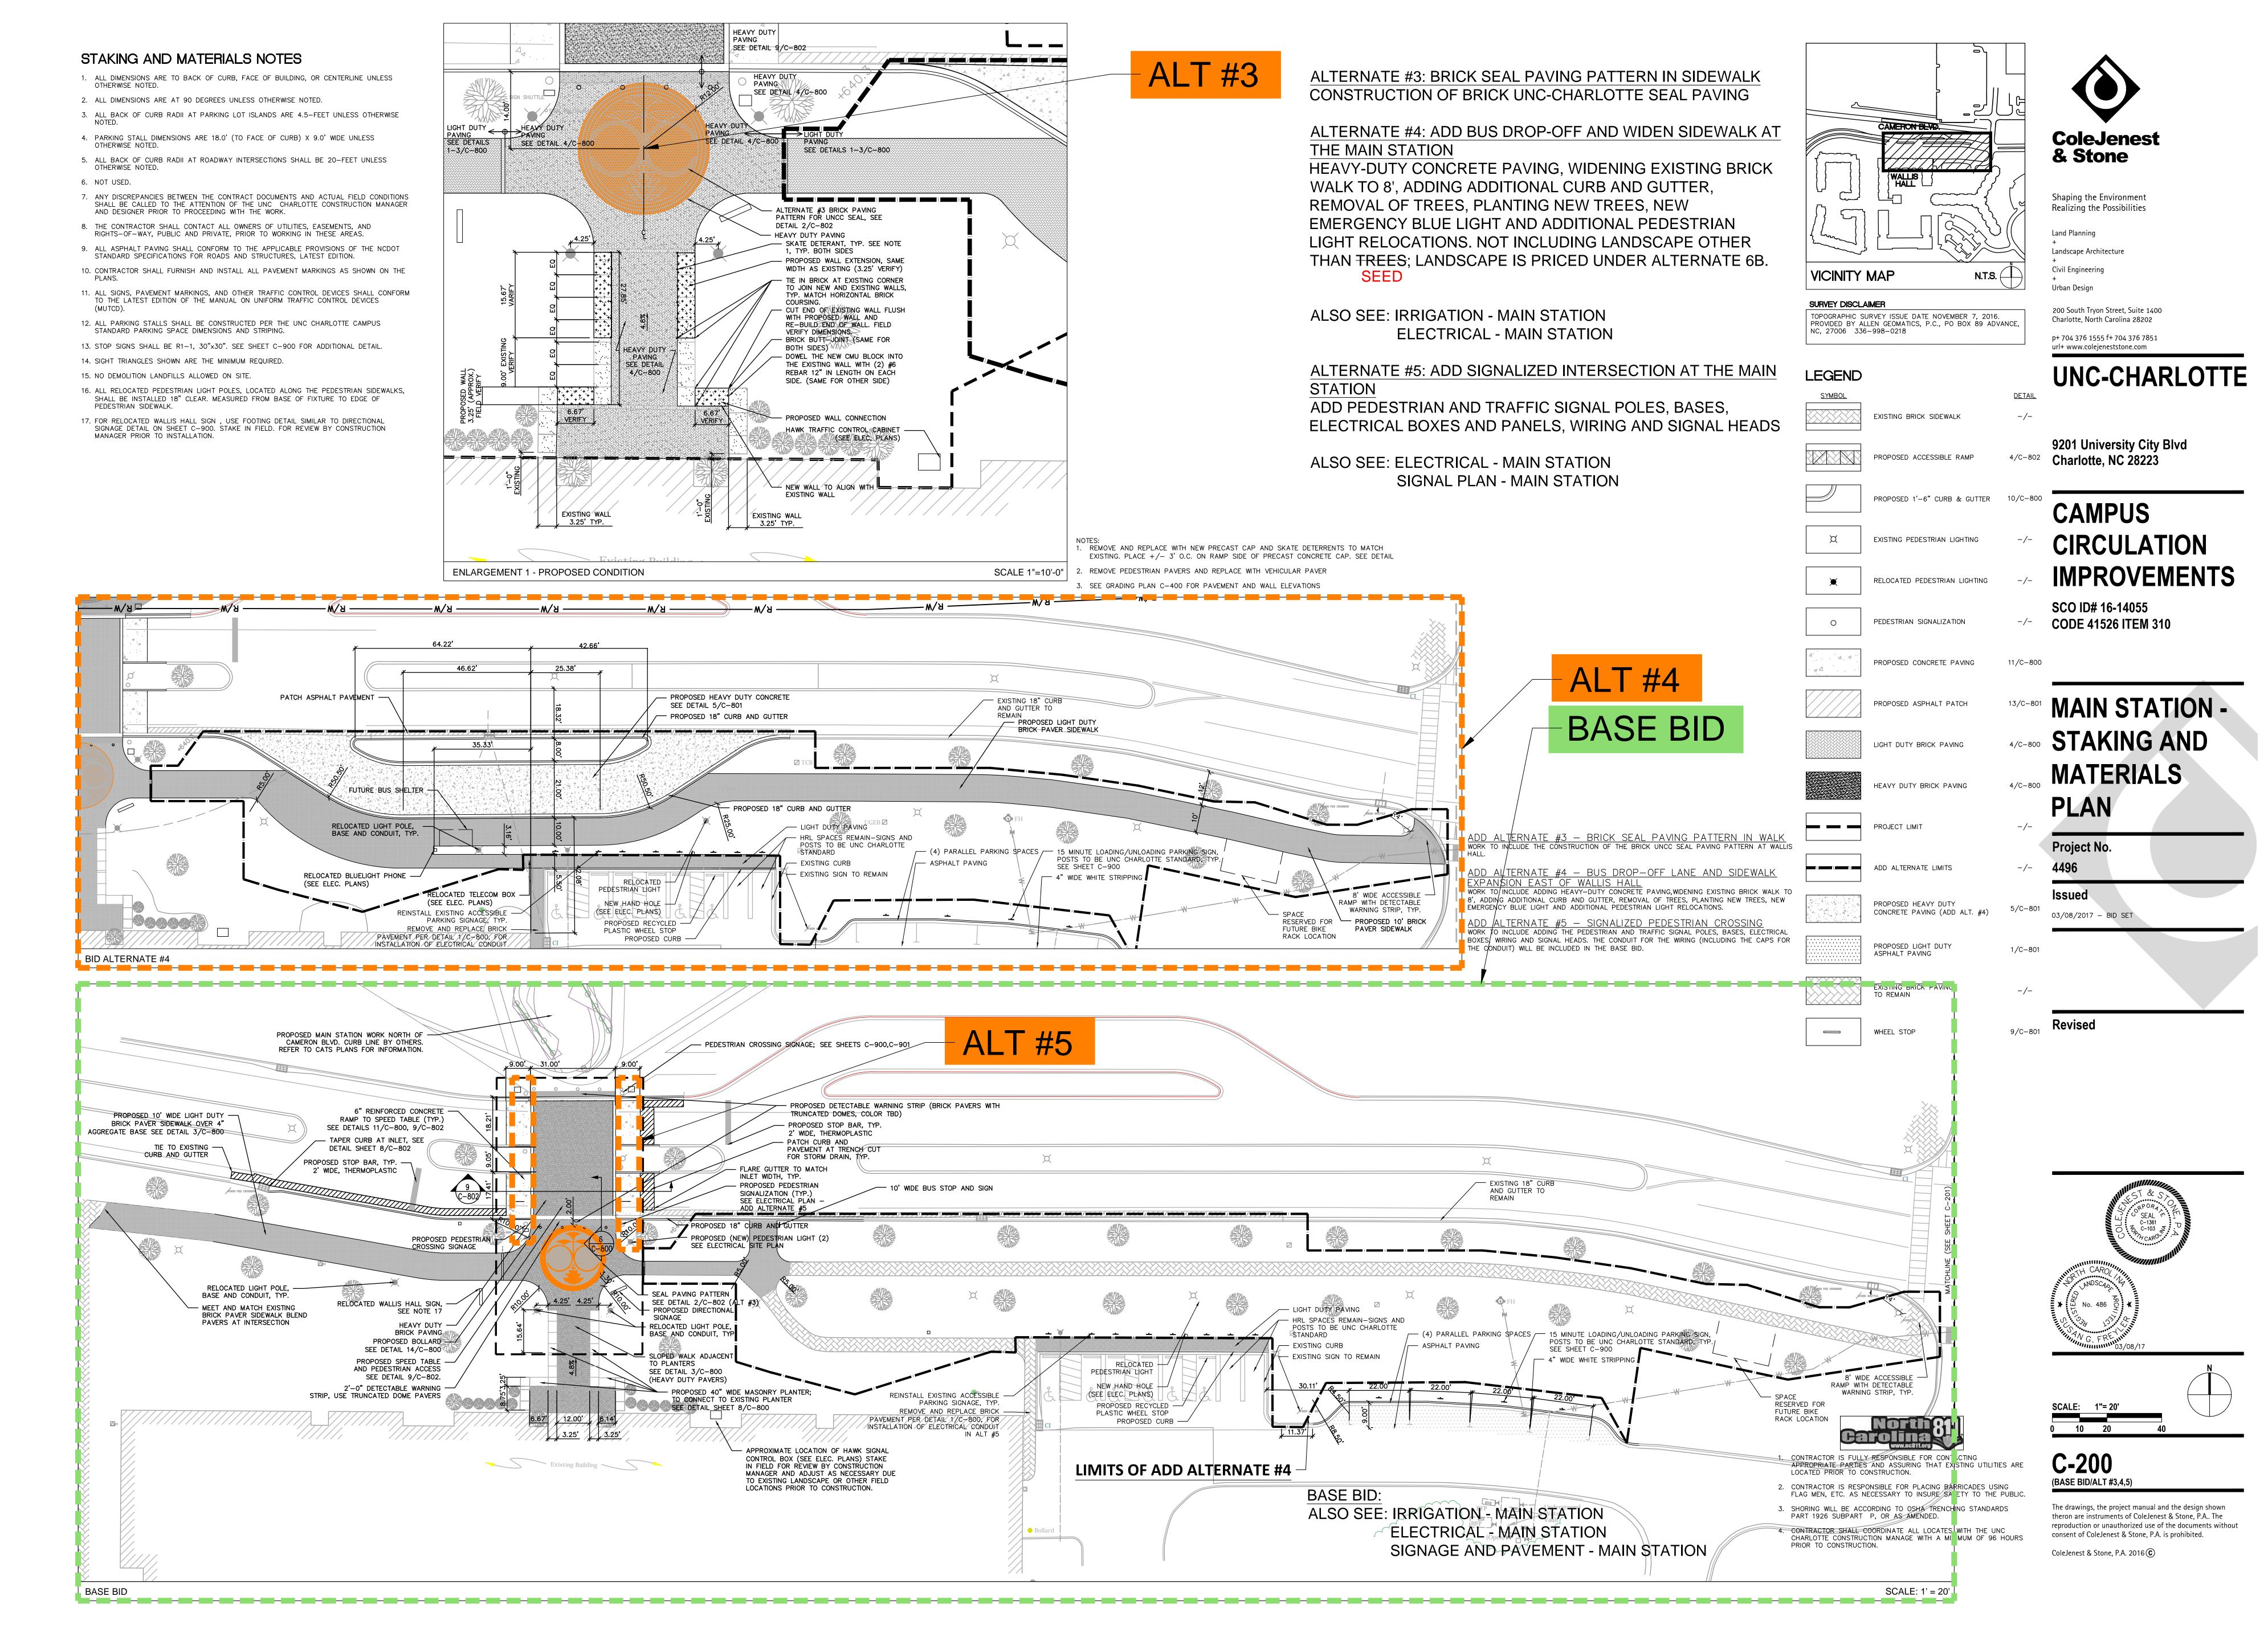EXISTING TREES TO REMAIN -

(80) LENTEN ROSE -

(80) LENTEN ROSE -

PLANT SCHEDULE ALTERNATE #6B PROPOSED PLANT TYPE PROPOSED PLANT SIZE PLANT SPACING 'WIRT L. WINN' HOLLY 7'–8' HT. AS SHOWN 4" CAL. AS SHOWN LIVE OAK CAMELLIA 'MAGNOLIAEFLORA' 36"-48" HT AS SHOWN LEUCOTHOE 'RAINBOW' 18"-24" SPR. AS SHOWN 8"-12" HT. 'WHITE PEARL' LENTEN ROSE AS SHOWN

8"-12" HT. LIRIOPE SPICATA AS SHOWN SOD (SEE SPECIFICATIONS)

— existin 🕏 tree to

ECB 🖸

PLANTING NOTES 1. SIZE AND GRADING STANDARDS OF PLANT MATERIAL SHALL CONFORM TO THE LATEST EDITION OF "USA STANDARDS FOR NURSERY STOCK", BY THE AMERICAN ASSOCIATION OF NURSERYMAN, INC. 2. HEIGHT AND WIDTH SPECIFICATIONS INDICATED ON PLAN SHALL TAKE PRECEDENCE OVER CONTAINER SIZE AND CALIPER. 3. CONTRACTOR SHALL MULCH ALL SHRUB BEDS WITH 4" AGED SHREDDED HARDWOOD BARK. CONTRACTOR SHALL MULCH ALL ANNUAL/PERENNIAL BEDS WITH 1" PINE BARK CAMERON BLVD. 4. ALL DISTURBED AREAS NOT OTHERWISE PLANTED SHALL BE SEEDED BY THE CONTRACTOR (BASE BID) OR SODDED BY THE CONTRACTOR (BID ALT 6A/6B) 5. CONTRACTOR SHALL REMOVE ALL HARD LUMPS OF CLAY, STONES OVER 1" IN DIAMETER, AND ALL CONSTRUCTION DEBRIS INCLUDING GRAVEL, ROOTS, LIMBS AND OTHER DELETERIOUS MATTER WHICH WOULD BE HARMFUL, OR PREVENT PROPER ESTABLISHMENT AND/OR MAINTENANCE OF LAWN AND PLANTING AREAS. 6. IN AREAS WHERE CONSTRUCTION GRAVEL IS EMBEDDED IN THE SOIL, CONTRACTOR SHALL REMOVE CONTAMINATED SOIL TO A DEPTH OF 18" AND FILL WITH CLEAN TOPSOIL CONTRACTOR SHALL IMPORT TOPSOIL AT NO CHARGE TO OWNER IF REQUIRED TO FILL THESE EXCAVATIONS. 7. CONTRACTOR SHALL RESOD LAWN AREAS DAMAGED DUE TO PLANT MATERIAL INSTALLATION.

BY THE CONTRACTOR FROM ROOT BALL PRIOR TO BACKFILLING PLANTING PIT. CONTRACTOR SHALL REMOVE TOP 1/3 OF THE BURLAP FROM ROOT BALL. FOR NEW TREE PLANTING AREAS, CONTRACTOR SHALL REMOVE ALL PAVEMENT, GRAVEL SUB-BASE AND CONSTRUCTION DEBRIS; REMOVE COMPACTED SOIL AND ADD 24" NEW TOPSOIL, OR AMEND THE TOP 24" OF EXISTING SOIL, TO MEET SPECIFIED TOPSOIL/PLANTING MIX STANDARDS FOR TREES. INCLUDE IN BASE BID

8. ALL STRAPPING AND TOP 2/3 OF WIRE BASKET SHALL BE CUT AWAY AND REMOVED

LARGE MATURING TREES SHALL BE A MINIMUM 25 TO 30 FEET FROM OVERHEAD DISTRIBUTION OR TRANSMISSION LINES. IF TREES CONFLICT WITH POWER LINES OR SIGNS, CONTRACTOR SHALL CONTACT LANDSCAPE ARCHITECT TO RESOLVE BEFORE

O. MINIMUM TREE SIZE AT PLANTING SHALL BE 3 INCH CALIPER FOR LARGE MATURING TREES AND 2 INCH CALIPER FOR SMALL MATURING TREES. ALL MULTI-STEM PLANTS SHALL BE TREE FORM, MAXIMUM THREE TO FIVE TRUNKS, AND A MINIMUM EIGHT FEET

1. INSTALLER SHALL BE RESPONSIBLE TO REPAIR OR REPLACE PLANTINGS THAT FAIL IN MATERIALS, WORKMANSHIP, OR GROWTH WITHIN SPECIFIED WARRANTY PERIOD (ONE YEAR FROM DATE OF FINAL ACCEPTANCE BY OWNER). 12. FOR SEEDED AREAS, AN ACCEPTABLE LAWN AT THE END OF THE MAINTENANCE PERIOD SHALL CONSIST OF A HEALTHY, UNIFORM, CLOSE STAND OF GRASS, FREE OF

WEEDS AND SURFACE IRREGULARITIES, WITH TOTAL GRASS COVERAGE EXCEEDING 90 PERCENT OVER ANY 10 SQ. FT. AND BARE SPOTS NOT EXCEEDING 5 BY 5 INCHES, WITH AT LEAST 85% OF THE TOTAL GRASS COVERAGE CONSISTING OF THE SPECIFIED

GRASS SPECIES. ANY AND ALL DAMAGE TO EXISTING IRRIGATION SYSTEM IS THE CONTRACTOR'S RESPONSIBILITY TO REPAIR. CONTRACTOR TO COORDINATE WITH CONSTRUCTION MANAGER TO ENSURE IRRIGATION TEAM INSPECTS THE REPAIR WORK BEFORE IT IS

TREE PROTECTION NOTES

TREE PROTECTION FENCING MUST BE INSTALLED BEFORE ANY DEMOLITION, CLEARING OR GRADING BEGINS, AND NOT REMOVED UNTIL FINAL INSPECTION. THE TREE PROTECTION FENCE SHALL BE LOCATED ALONG THE PERIMETER OF THE TREE SAVE AREA (DRIP LINE PLUS 5 FEET). TREE PROTECTION FENCING FOR A FOREST CANOPY STAND AREA IS TO BE LOCATED ALONG THE PERIMETER OF THE TREE SAVE AREA AROUND THE FOREST EDGE. TREE PROTECTION FENCING SHALL CONSIST OF ORANGE SAFETY FENCING OR A COMBINATION OF ORANGE SAFETY FENCING WITH SILT FENCING AT A MINIMUM OF 4 FEET IN HEIGHT ON METAL OR WOOD POSTS.

. NO SOIL DISTURBANCE OR COMPACTION, STOCK PILING OF SOIL OR OTHER CONSTRUCTION MATERIAL, VEHICULAR TRAFFIC, OR STORAGE OF EQUIPMENT AND MATERIALS ARE ALLOWED WITHIN THE TREE SAVE AREA. NO ROPES, SIGNS, WIRES, UNPROTECTED ELECTRICAL INSTALLATION OR OTHER DEVICE

ALL PROTECTIVE MEASURES SHALL BE MAINTAINED THROUGHOUT THE LAND DISTURBING AND CONSTRUCTION PROCESS, AND SHALL NOT BE REMOVED UNTIL FINAL LANDSCAPING IS INSTALLED.

ADD ALT #6A

VICINITY MAP

SURVEY DISCLAIMER

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TOPOGRAPHIC SURVEY ISSUE DATE NOVEMBER 7, 2016.

EXISTING TREELINE

PROPOSED TREELINE

PROPOSED TREE

PROPOSED SHRUBS


PROPOSED SOD

PROPOSED GROUNDCOVER

PROPOSED LIGHT FIXTURE SEE ELECTRICAL PLAN

PROVIDED BY ALLEN GEOMATICS, P.C., PO BOX 89 ADVANCE,

ADD ALT #6B

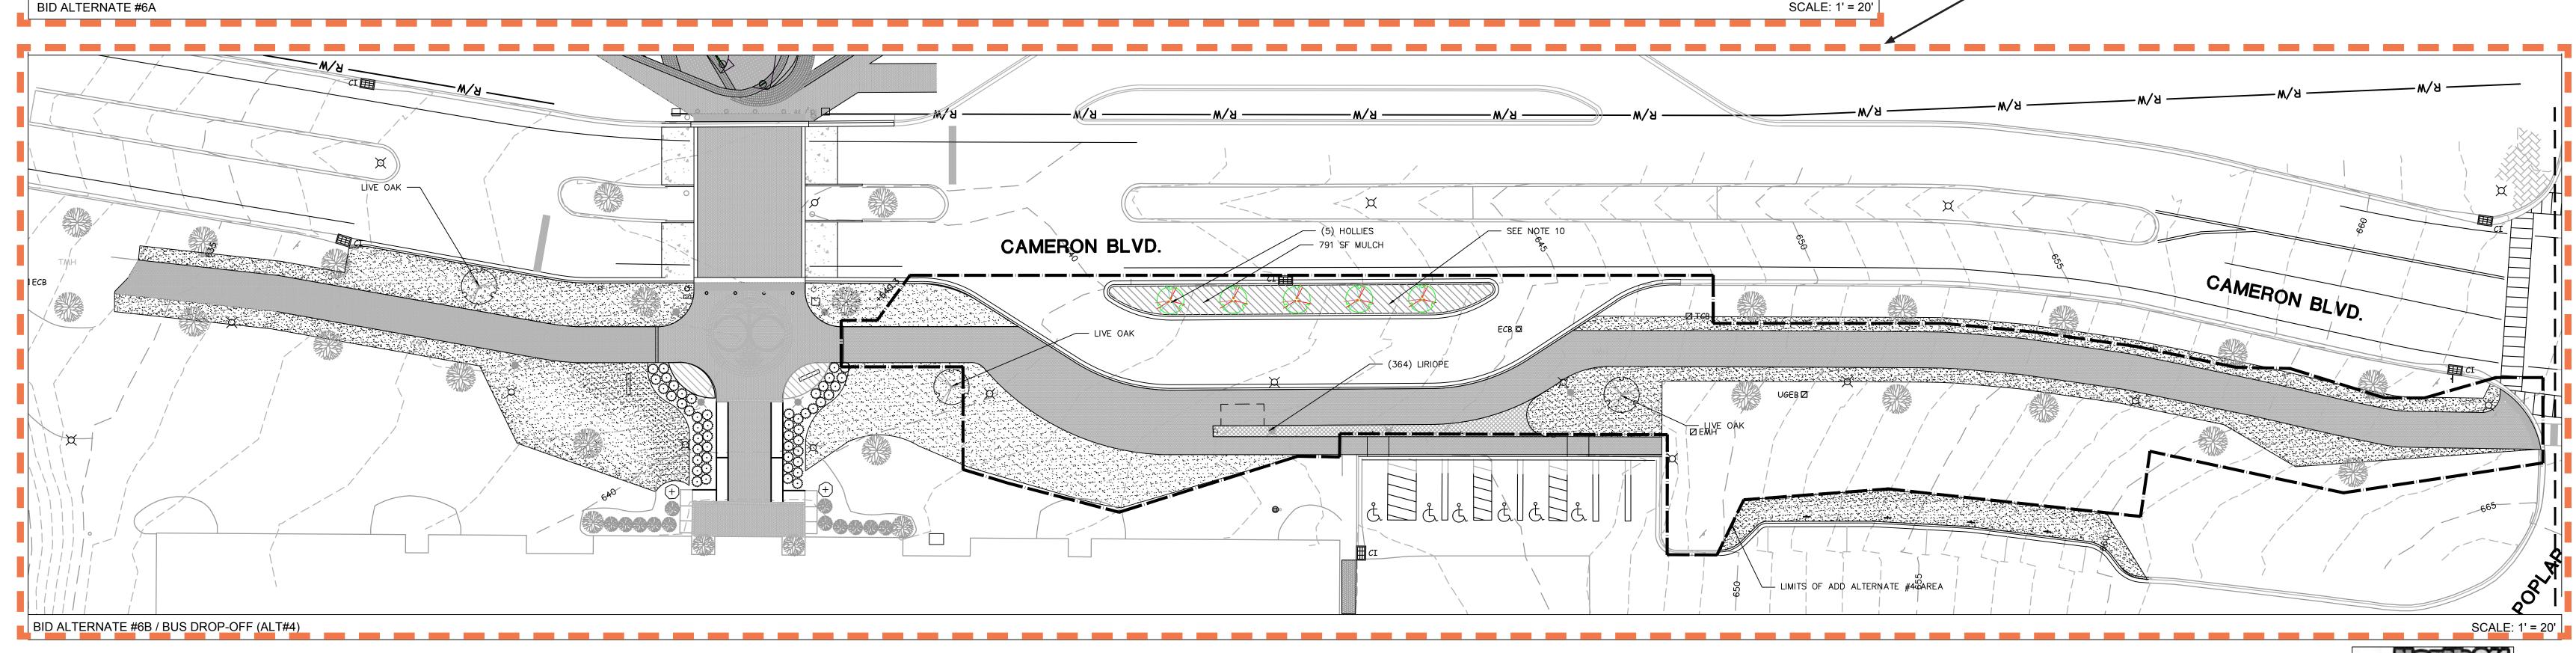

· LIMITS OF ADD ALTERNATE #4 AREA

CAMERON BLVD.

EXISTING PLANT MATERIAL TO REMAIN

1. CONTRACTOR IS FULLY RESPONSIBLE FOR CONTACTING

LOCATED PRIOR TO CONSTRUCTION.

2. CONTRACTOR IS RESPONSIBLE FOR PLACING BARRICADES USING FLAG MEN, ETC. AS NECESSARY TO INSURE SAFETY TO THE PUBLIC.

APPROPRIATE PARTIES AND ASSURING THAT EXISTING UTILITIES ARE

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UNC-CHARLOTTE


9201 University City Blvd


CAMPUS 17/C-801 CIRCULATION **IMPROVEMENTS**

> SCO ID# 16-14055 **CODE 41526 ITEM 310**

-/- MAIN STATION -PLANTING PLAN (WALLIS HALL)

Revised

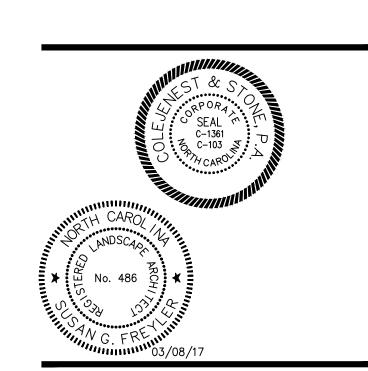


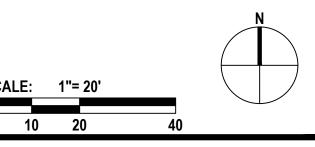

(BASE BID/ALT. #6A/6B)

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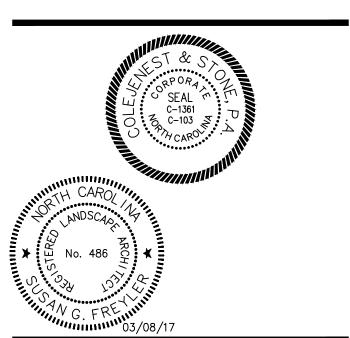
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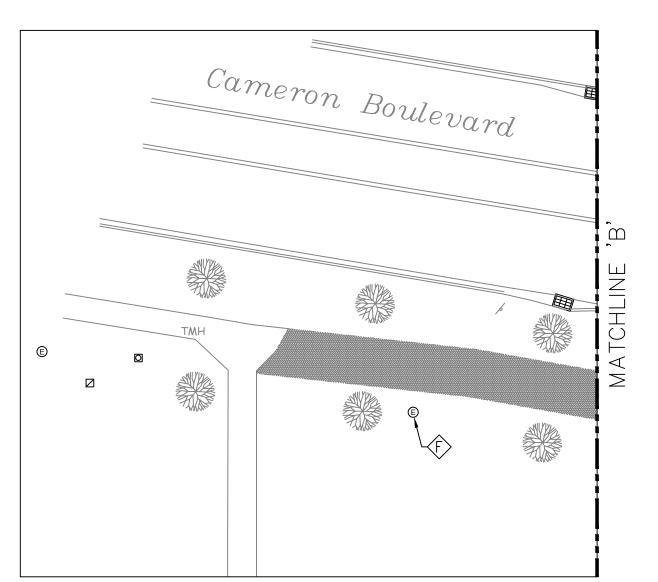
CIRCULATION

SCO ID# 16-14055

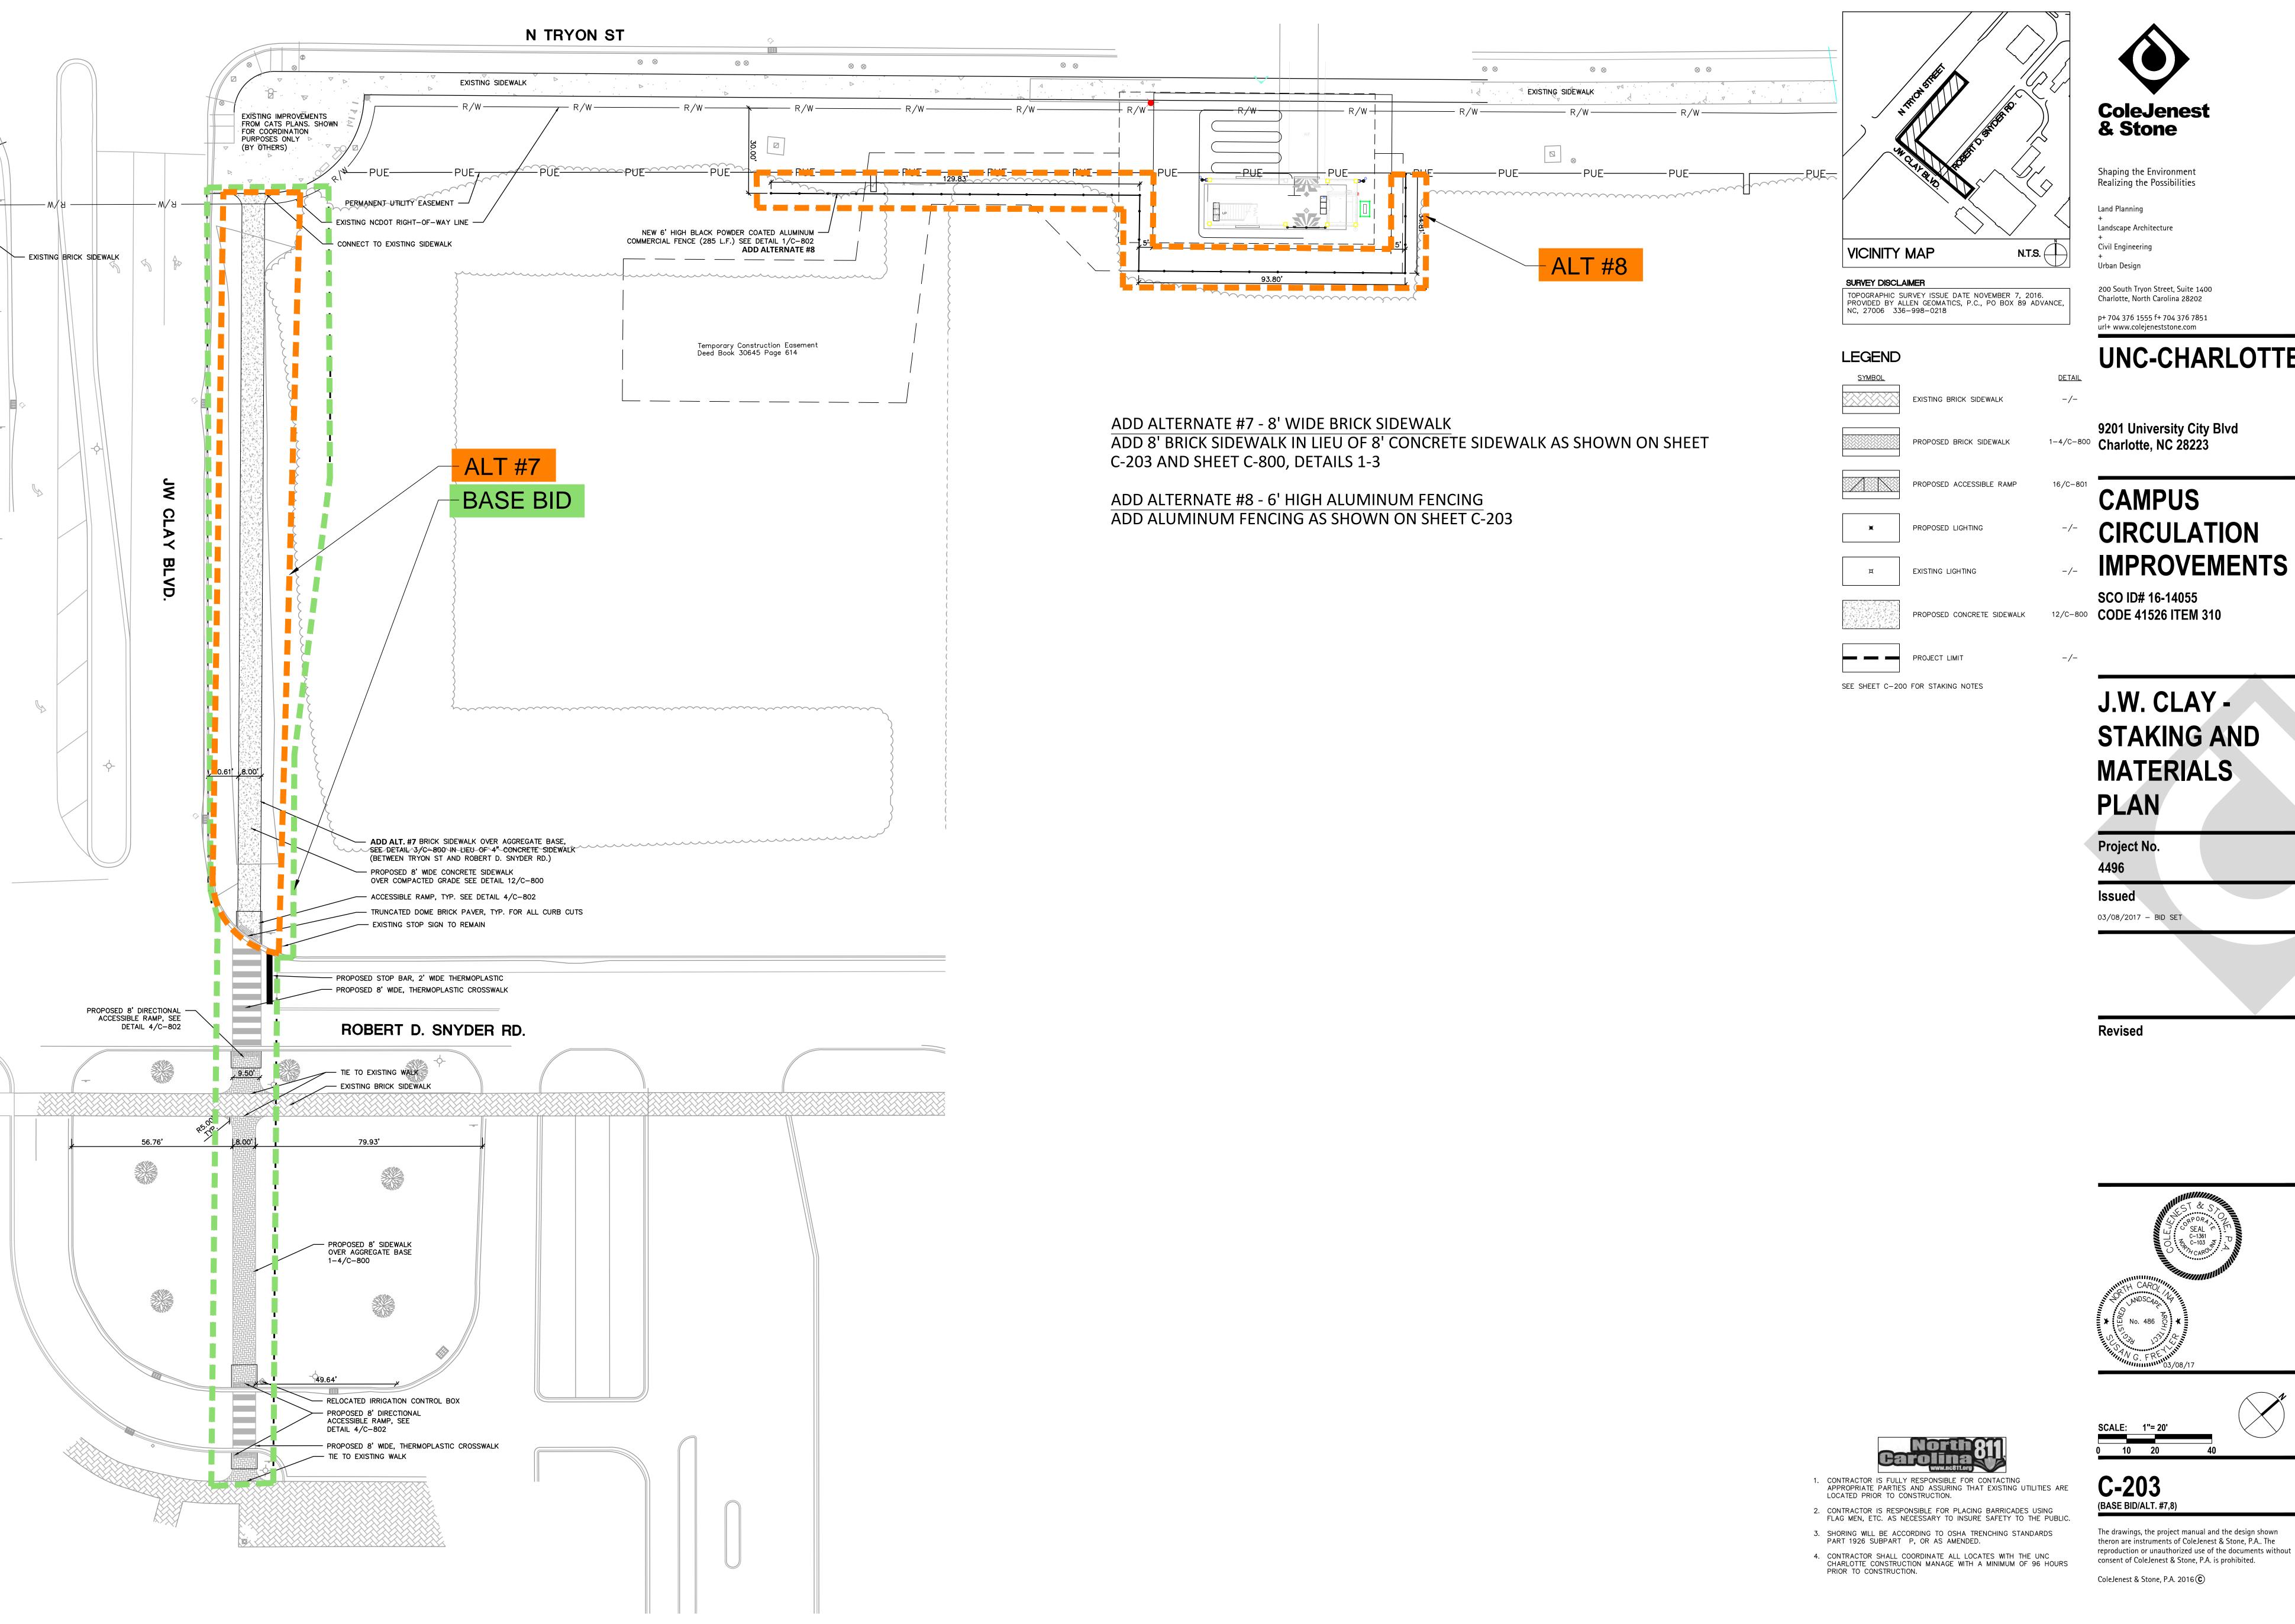J.W. CLAY -STAKING AND MATERIALS



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GENERAL NOTES:


- ALL ELECTRICAL LINES SERVING NEW PEDESTRIAN AND TRAFFIC CONTROLS SHALL BE LOCATED UNDERGROUND.
 PROVIDE TRAFFIC RATED HAND HOLES AS NECESSARY FOR ROUTING CONDUITS UNDER GROUND AND RECONNECT EXISTING SITE LIGHTING.
- 3. SEE PLANTING PLAN FOR TREE LOCATIONS
- 4. REFER TO CIVIL PLANS FOR EXISTING POLES TO REMAIN, BE RELOCATED, OR TO BE REMOVED. PROVIDE NEW WIRING (2#10, 1#10, 1"C) TO EXTEND EXISTING CIRCUITS TO NEW LIGHT POLE LOCATIONS.
- 5. PROVIDE STAINLESS STEEL LOCKABLE GASKETED ENCLOSURE TO PROTECT EQUIPMENT & CONTROLS FOR EACH TRAFFIC CONTROL CABINET.
- 6. COORDINATE AND CONFIRM FINAL LOCATION OF LIGHTS WITH UNCC CONSTRUCTION MANAGER IN THE EVENT A PROPOSED LIGHT POLE LOCATION IS IN CONFLICT WITH AN EXISTING OR PROPOSED UTILITY.
- . CONTRACTOR SHALL BE FULLY RESPONSIBLE TO CALL NORTH CAROLINA ONE—CALL CENTER (1—800—632—4949)
 AND UNIVERSITY OF NORTH CAROLINA AT CHARLOTTE AT LEAST 48 HOURS PRIOR TO UNDERGROUND WORK TO
 HAVE EXISTING UTILITIES LOCATED. REPORT ANY DISCREPANCIES TO THE ENGINEER.
- 8. CONTRACTOR SHALL BE FULLY RESPONSIBLE TO CONTRACT WITH PRIVATE UTILITY LOCATOR TO HAVE ALL EXISTING UTILITIES LOCATED.
- 9. ALL EXISTING UTILITIES ARE SHOWN AT APPROXIMATE LOCATIONS. CONTRACTOR IS FULLY RESPONSIBLE TO FIELD VERIFY ACTUAL LOCATION AND DEPTH OF EXISTING UTILITIES PRIOR TO THE START OF CONSTRUCTION.
- 10. THE CONTRACTOR SHALL ENSURE THAT ALL OCCUPATIONAL SAFETY AND HEALTH ADMINISTRATION (OSHA)
 REGULATIONS AND STANDARDS ARE FOLLOWED DURING ALL PHASES OF THE CONSTRUCTION PROJECT. SHEETING OR
 BRACING SHALL BE USED WHENEVER NECESSARY TO PREVENT FAILURE OF THE TRENCH BANKS. ALL SHEETING
 SHALL CONFORM TO AASHTO AND OSHA SAFETY STANDARDS.
- 11. THE CONTRACTOR SHALL BE FULLY RESPONSIBLE TO PROVIDE SIGNS, BARRICADES, WARNING LIGHTS, GUARD RAILS, AND EMPLOY FLAGGERS AS NECESSARY WHEN CONSTRUCTION ENDANGERS EITHER VEHICULAR OR PEDESTRIAN TRAFFIC. THESE DEVICES SHALL REMAIN IN PLACE UNTIL THE TRAFFIC MAY PROCEED NORMALLY AGAIN.
- 12. CONSTRUCTION WORK ZONE SIGNS AND SIGNING PROCEDURES SHALL CONFORM TO THE MUTCD AND SUPPLEMENTS AND TO ALL APPLICABLE FEDERAL, STATE, AND LOCAL CODES.
- 13. SEE SHEET C-900 FOR LOCATION OF PEDESTRIAN SIGNAL POLES.
- 14. ADJUST ALL EXISTING ELECTRICAL HAND HOLES VERTICALLY AND HORIZONTALLY AS REQUIRED TO AVOID NEW CONDITIONS, FLUSH WITH SURROUNDING SURFACES AND COORDINATE WITH CIVIL DRAWINGS AND OWNER FINAL

KEY NOTES

- NEW 12" X 12" HAND HOLE FOR SITE LIGHTING CIRCUITS PROVIDE NEW 2#10, 1#10G, 1"C TO RECONNECT EXISTING CIRCUIT.
- LOCATION FOR RELOCATED EXISTING SITE LIGHTING POLE. SEE DETAIL FOR PAVER MOUNTING. PROVIDE NEW POLE BASE. EXTEND CONDUIT AND RECONNECT TO EXISTING SITE LIGHTING CIRCUIT WITH 2#12, 1#12G, 1"C.
- NEW SIGNAL LIGHT AND POLE, DECORATIVE TO MATCH PEDESTRIAN LIGHTING POLES. SEE SHEET C-900 & C-901, SEE DETAIL 12/E-102, COORDINATE FINAL STYLE, HEIGHT, FINISH, LOCATION, ETC. WITH C.M.
- PROVIDE CONDUIT SLEEVES TO ENCLOSE EXISTING EXPOSED WIRING INTO ENCLOSURES


 PROVIDE NEW 24"X24"X18" D HAND HOLE FOR POWER DISTRIBUTION
- PROVIDE NEW 24"X24"X18" D HAND HOLE FOR POWER DISTRIBUTION

 F PROVIDE UL LISTED LED RETROFIT KIT FROM ORIGINAL EQUIPMENT MANUFACTURER
- © EXISTING SITE STREET LIGHT TO REMAIN.
- PROVIDE (4) 20A-120V NEMA 5-20R GFCI RECEPTACLES FOR TRAFFIC CONTROL SYSTEM.
- PROVIDE NEW STAINLESS STEEL PANELBOARD ENCLOSURE, ON 60"x36" CONCRETE PAD, SEE DETAIL.
- J EXISTING BLUE LIGHT TO REMAIN UNDER BASE BID. REMOVE EXISTING BLUE LIGHT PHONE, ASSOCIATED CONDUIT, WIRE AND HAND HOLES UNDER ALTERNATE #4.
- LOCATION FOR NEW BLUE LIGHT PHONE AND ASSOCIATED EQUIPMENT. PROVIDE NEW 2#10, 1#10G IN 1"C TO NEW LOCATION. COORDINATE WITH UNCC I.T. STAFF FOR NEW TELECOM CABLE. PROVIDE 1½"C TO WALLIS BLDG I.T. ROOM. PROVIDE ONE 12" X 12" HAND HOLE FOR POWER AND ONE 12" X 12" HAND HOLE FOR TELECOM.
- EXTEND EXISTING CIRCUIT TO NEW PEDESTRIAN LIGHT POLE LOCATION.
- M NEW PEDESTRIAN LIGHT POLE LOCATION, PROVIDE NEW BASE, POLE AND LIGHT TO MATCH EXISTING SURROUNDING PEDESTRIAN DECORATIVE 'ANP' FIXTURES AND POLES. SEE DETAIL 6/E-102 PROVIDE UL LISTED LED KIT TO MATCH RETROFIT FIXTURES. COORDINATE WITH OWNER.
- EXISTING PEDESTRIAN LIGHT POLE LOCATION, PROVIDE NEW POLE AND LIGHT TO MATCH EXISTING SURROUNDING PEDESTRIAN DECORATIVE 'ANP' FIXTURES AND POLES, MOUNT TO EXISTING BASE AND CONNECT TO EXISTING CIRCUIT. PROVIDE UL LISTED LED KIT TO MATCH RETROFIT FIXTURES. COORDINATE WITH OWNER.

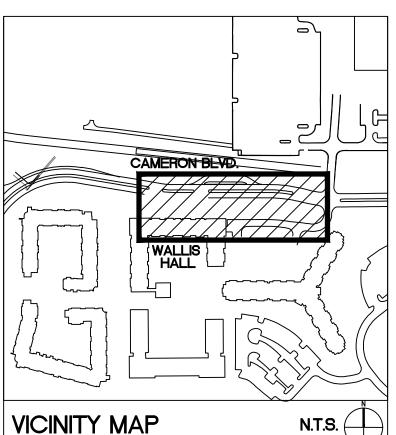

SURVEY DISCLAIMER

TOPOGRAPHIC SURVEY ISSUE DATE NOVEMBER 7, 2016.
PROVIDED BY ALLEN GEOMATICS, P.C., PO BOX 89 ADVANCE,
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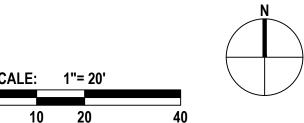
CAMPUS CIRCULATION IMPROVEMENTS

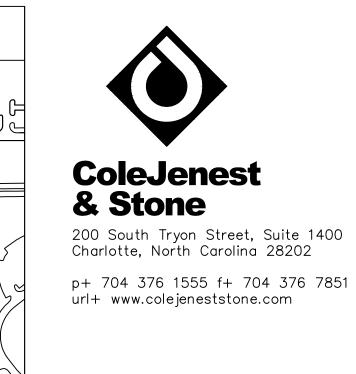SCO ID# 16-14055 CODE 41526 ITEM 310



Revised







F-200

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INSTALL A 16AWG TRACER WIRE WITH NEW MAINLINE.

VALVE BOX AT EACH END.

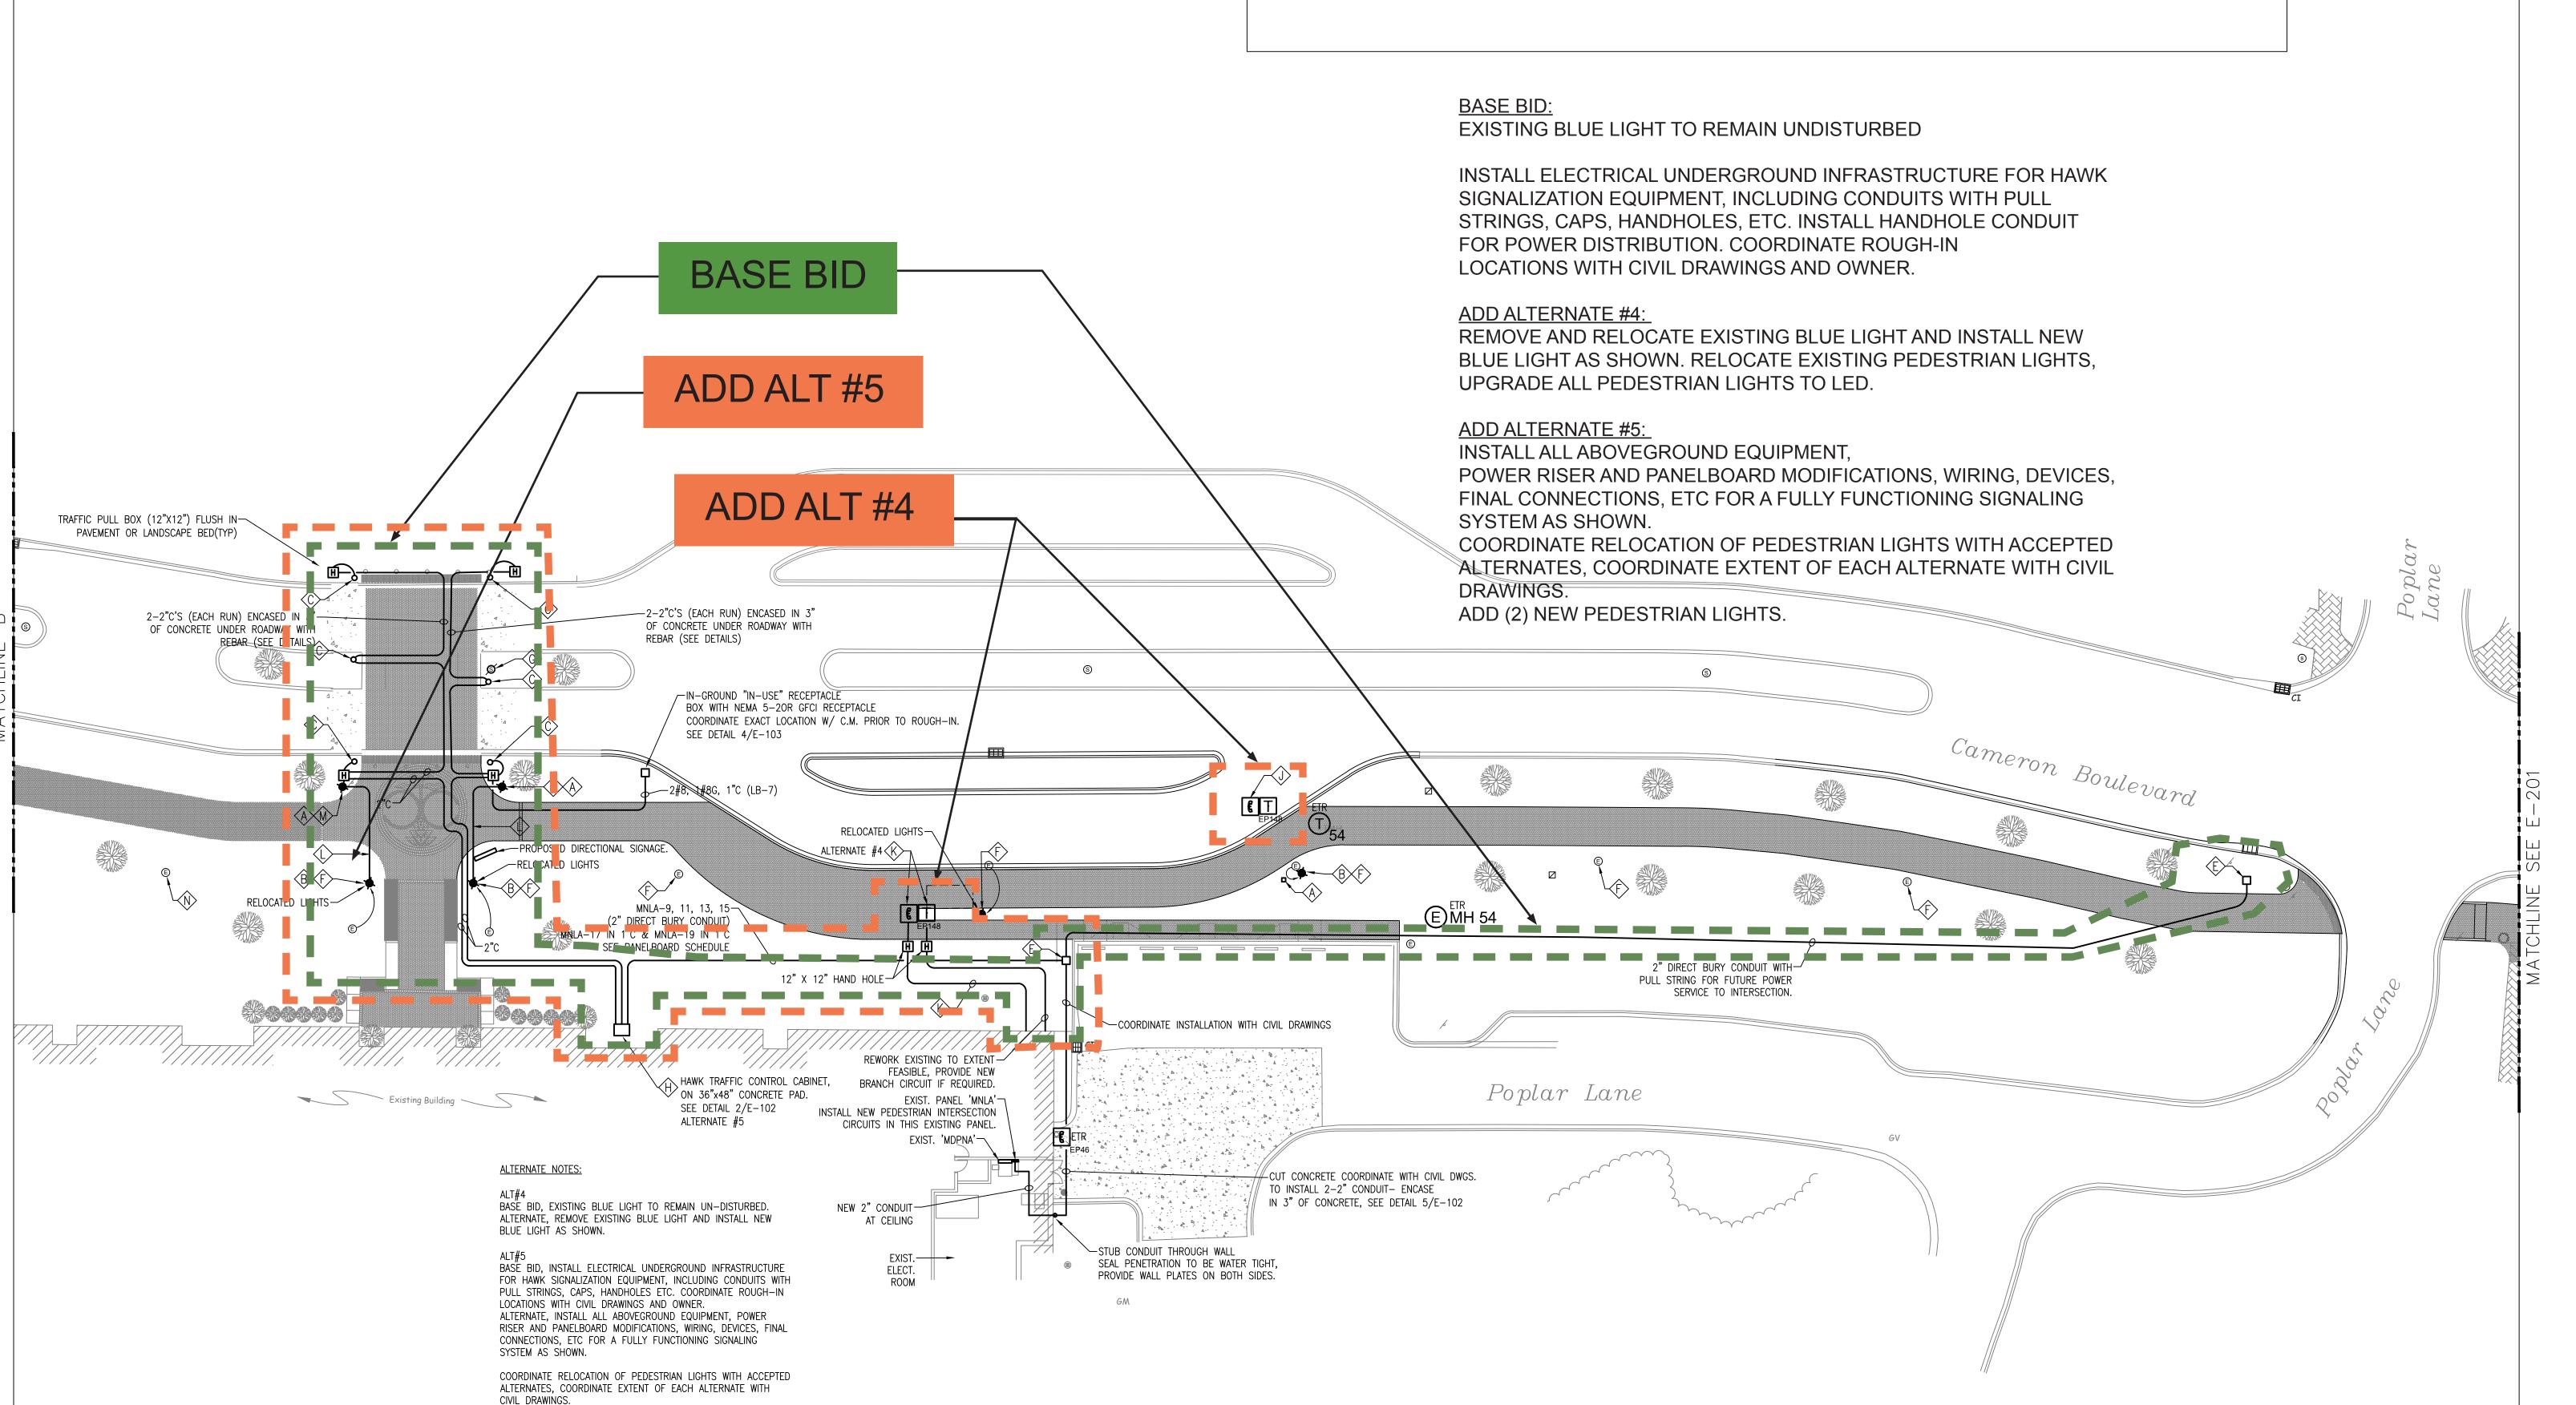MODIFY EXISTING IRRIGATION IN THIS —

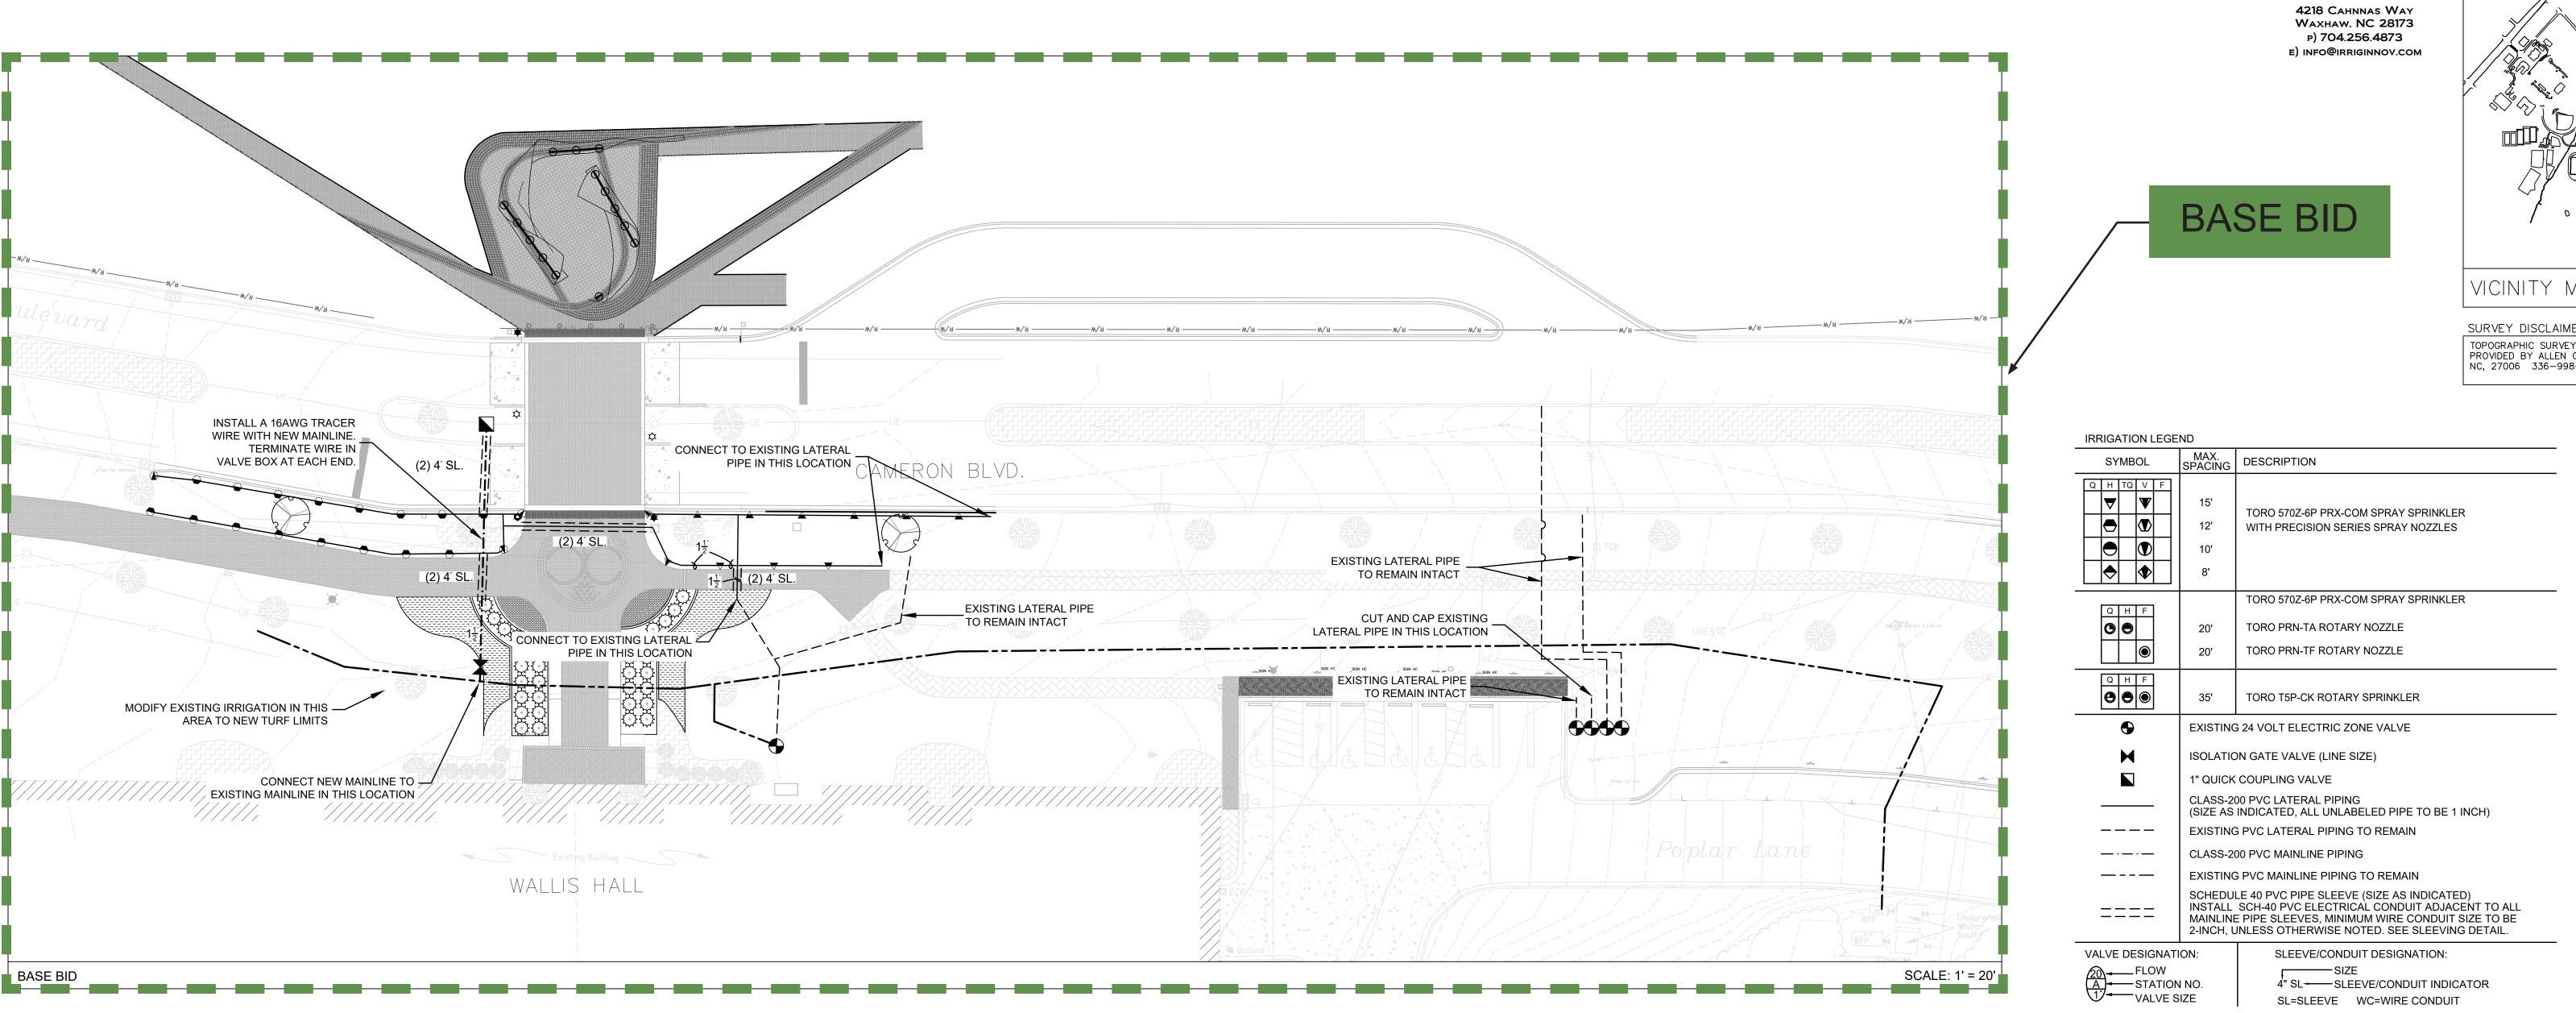CONNECT NEW MAINLINE TO EXISTING MAINLINE IN THIS LOCATION

AREA TO NEW TURF LIMITS


FROM CONTROL VALVE AND CAP.
CONNECT NEW LATERAL AS SHOWN.

WALLIS HALL

REMOVE EXISTING SPRINKLERS IN

SPRINKLERS TO OWNER

TERMINATE WIRE IN

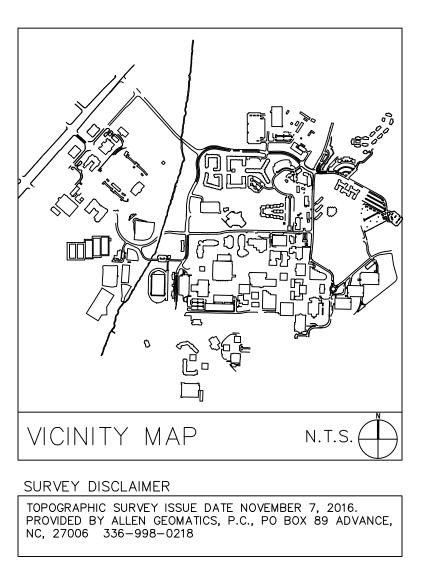

IRRIGATION
INNOVATIONS, LLC

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Landscape Architecture
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CAMPUS CIRCULATION IMPROVEMENTS

SCO ID# 16-14055 CODE 41526 ITEM 310

MAIN STATION - IRRIGATION PLAN


Project No


4430

Issue

02/27/2017 - CD SCO SUBMITTAL

Revised

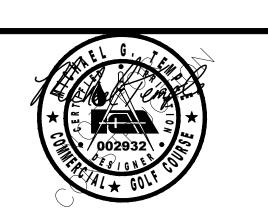

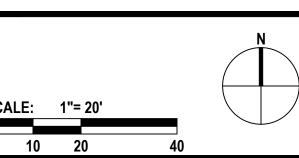

I-100(BASE BID/ALT. #6A/6B)

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ADD ALT #4

CUT EXISTING LATERAL PIPE AND CONNECT

NEW LATERALS IN THIS LOCATION

FROM CONTROL VALVE AND CAP. CONNECT NEW LATERAL AS SHOWN.

SCALE: 1' = 20'


ADJACENT TO EXISTING SPRINKLERS

- CONTRACTOR IS FULLY RESPONSIBLE FOR CONTACTING
 APPROPRIATE PARTIES AND ASSURING THAT EXISTING UTILITIES ARE LOCATED PRIOR TO CONSTRUCTION.
- CONTRACTOR IS RESPONSIBLE FOR PLACING BARRICADES USING FLAG MEN, ETC. AS NECESSARY TO INSURE SAFETY TO THE PUBLIC.
 SHORING WILL BE ACCORDING TO OSHA TRENCHING STANDARDS PART 1926 SUBPART P, OR AS AMENDED.

North 911

4. CONTRACTOR SHALL COORDINATE ALL LOCATES WITH THE UNC CHARLOTTE CONSTRUCTION MANAGER PRIOR TO CONSTRUCTION.

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W11-15 36″ X 36″ **《** (BASE BID)

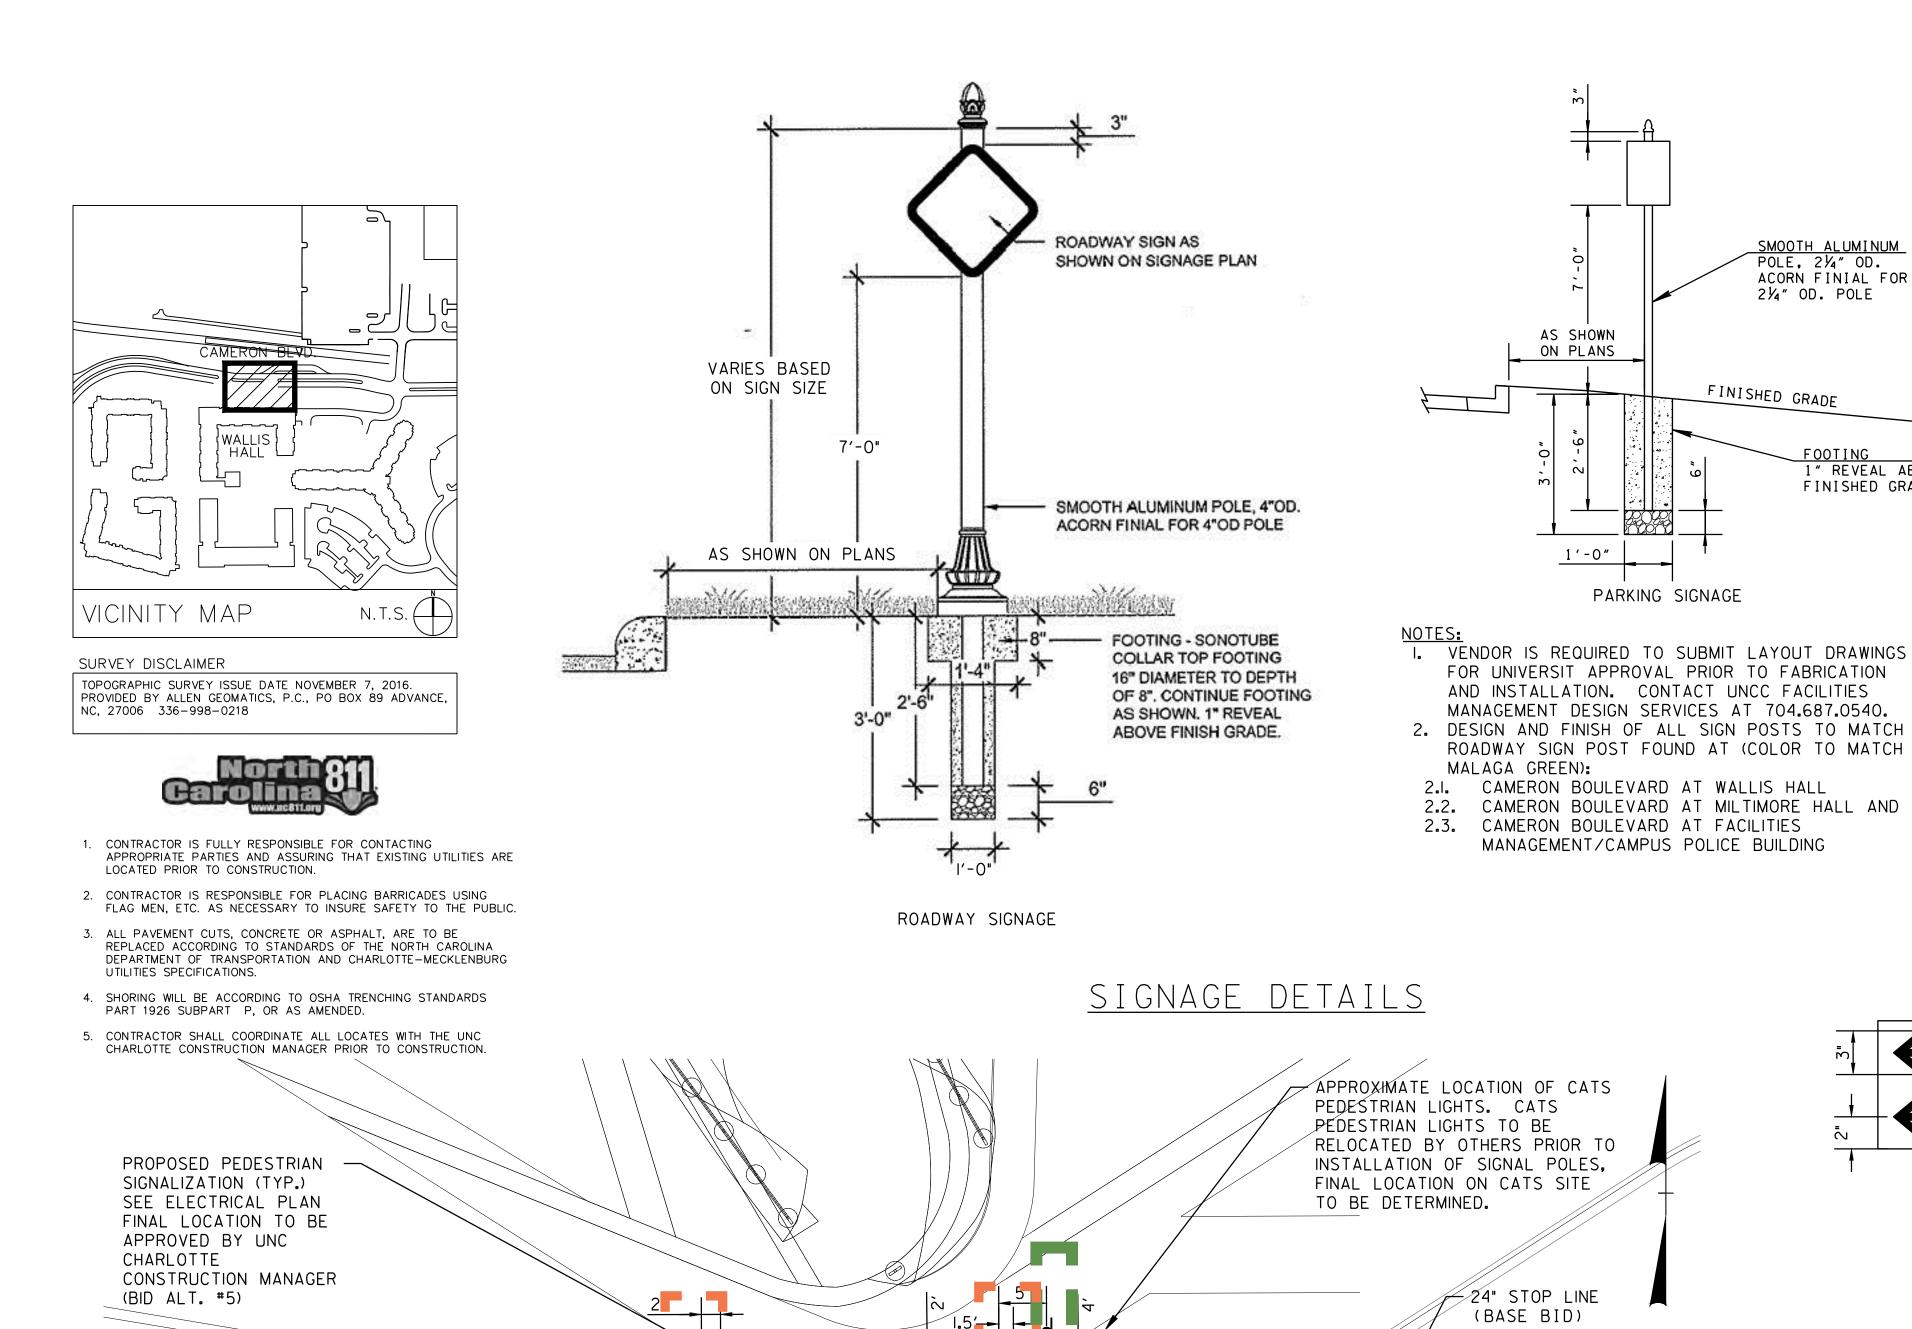- W16-7PL 24" X 12" (BASE BID)

40′

TO REMAIN

_ EXISTING STREET LIGHT

- PROPOSED PEDESTRIAN SIGNALIZATION (TYP.) SEE ELECTRICAL PLAN

PROPOSED DIRECTIONAL

SIGNAGE (SEE DETAIL

THIS SHEET)

(BASE BID)

(BID ALT. #5)

APPROXIMATE LOCATION OF CATS PEDESTRIAN

RELOCATED BY OTHERS PRIOR TO INSTALLATION

40′

25'

W16-7PL 24" X 12" (BASE BID)

OF SIGNAL POLES, FINAL LOCATION ON CATS

 $\mathrel{\rlap{$\sqsubseteq}}$ 24" STOP LINE

RELOCATED WALLIS

HALL SIGN

(BASE BID)

(BASE BID)

LIGHTS. CATS PEDESTRIAN LIGHTS TO BE

SITE TO BE DETERMINED.

CAMERON BLVD.

ALL SIGNS SHOWN WITH DESIGNATIONS ARE TO BE FABRICATED AS DETAILED IN THE "MANUAL ON UNIFORM TRAFFIC CONTROL DEVICES" (CURRENT EDITION)

POLE, 2¼" OD.

FINISHED GRADE

- PROJECT LIMIT

ADD ALT #5

BASE BID

ACORN FINIAL FOR 21/4" OD. POLE

> FOOTING 1" REVEAL ABOVE FINISHED GRADE

> > FONT: UTOPIA (TYP.)

Fretwell, Cato

Student Union,

King, Reese

Center

Student Activity

DIRECTIONAL PANEL

UNCC TO REVIEW AND APPROVE BUILDING

NAMES TO BE USED ON DIRECTIONAL PANEL

4'-10"

MAP PANEL

PROVIDED BY UNCC)

DIRECTIONAL PANEL

3'-7"

FRONT VIEW

(MAP GRAPHIC TO BE

l'-4"

Charlotte

Pavilion

Research Institute

Hauser Alumni

		SI	ZE	SIGN FACE		STEEL DESIGN		MINIMUM	0		
L E C	GEND '		LENGTH	HEIGHT	COPY	BACKGROUND	MATERIAL	SUPPORT TYPE	SUPPORT LENGTH	VERTICAL CLEARANCE	QUANTITY
(A)	W11-15		30″	30″	BLACK	FLUOR. YELLOW GREEN (REF.)	0.080″ SHEET ALUMINUM	SEE ROADI SIGNAGE DE		8′-3″	2
	W16-7PL		24"	12″	BLACK	FLUOR. YELLOW GREEN (REF.)	0.080" SHEET ALUMINUM	MOUNTED WITH	W11-15	7′-0″	2
15 MIN PARKING TOW-AWAY ZONE	R7-5(MOD *OWNER TO A TEXT PRIOR FABRICATION	APPROVE TO	12″	18″	WHITE	GREEN (REF.)	0.080″ SHEET ALUMINUM	SEE PARK SIGNAGE DE		7′-0″	4
NO PARKING BUS STOP	R7-7		12"	18″	RED	WHITE (REF.)	0.080" SHEET ALUMINUM	SEE PARK SIGNAGE DE		7′-0″	1

SIGN SCHEDULE DETAIL

GENERAL NOTES

- I. SIGNAGE SHOULD COMPLY WITH UNIVERSITY OF NORTH CAROLINA AT CHARLOTTE DESIGN AND CONSTRUCTION MANUAL SECTION 3, ANNEX D CAMPUS EXTERIOR SIGNAGE STANDARDS
- 2. POST STOCK ALUMINUM 3"X4" SQUARE TUBE WELDED AT 45 DEGREE CUT JOINT INTERSECTION WITH INTERNAL REINFORCED SUPPORTS. 3. HEADER BOARD - ASSEMBLY PAINTED IN CAMPUS GREEN, AND AFFIXED WITH
- BOTH MECHANICAL FASTENERS AND ADHESIVE SYSTEMS. 4. CROWN ASSEMBLY - AFFIXED TO BAND AS FEATURE, WITH GOLD AREA BEING
- 04 GOLD VINYL OR PAINT EQUAL, AND DARK GREEN AREA PAINTED TO MATCH SIGN BODY AND POSTS 5. SIGN BODY - ALUMINUM WITH CHANNEL EDGE (SEE DETAIL SHEET), AFFIXED
- WITH MECHANICAL FASTENERS, AND FILLER FINISH FOR BLENDING WITH PAINTED SURFACES. STAINLESS STEEL HINGE. LED INTERIOR CABINET LIGHTING.
- 6. FOOTER SUPPORT -3"X72" 'C' CHANNEL STEEL METAL FOOTING BAR. ¾" DIAMETER STAINLESS STEEL HARDWARE ASSEMBLY AND #4 REBAR CROSS
- 7. FASTENERS ₹ SS BOLT ASSEMBLY AND I ACCESS HOLES OPPOSITE OF (E)
- FASTENERS MUST BE PLUGGED WITH PAINTED 'SNAP IN' CAP. 8. FOOTING IS 12" DIAMETER POST HOLE 42" IN DEPTH POURED -1" FINISHED


FINISH NOTES

9003 SIGNAL WHITE

- I. POSTS AND SIGN BODY: 'BLACK GREEN' MATTHEWS PAINT CO. MP2I337 R91290 - SATIN FINISH AND SATIN CLEAR COAT TO SEAL. ALTERNATE - RAL 6012 BLACK GREEN
- 2. HEADER ASSEMBLY: CAMPUS GREEN PMS 349 MATTHEWS PAINT CO. MPO0457 R91290 SATIN FINISH AND SATIN CLEAR COAT TO SEAL.
- 3. CANOPY ASSEMBLY: 'NATURAL WHITE LRV' MATTHEWS PAINT CO. MP42202SP R282204SP SATIN FINISH AND SATIN CLEAR COAT TO SEAL. ALTERNATE RAL
- 4. TEXT GRAPHICS/LETTERING: 3M DIAMOND GRADE PRISMATIC OR EQUAL WHITE HIGH PERFORMANCE VINYL.
- 5. LOGO: GOLD CROWN ARLON 04 OR EQUAL. INSET OR SECOND COLOR TO MATCH SIGN BODY PAINT CODE.

ALL SURFACES TO BE SMOOTH AND FREE OF OBVIOUS DEFECTS; VOIDS FILLED WHERE NECESSARY. ALUMINUM TO BE PRIME COATED TO ACCEPT FINISHES.

FOR ALL LAYOUTS ON EXTERIOR SIGNAGE, THE VENDOR MUST PROVIDE SUBMITTAL DRAWINGS WITH LAYOUT AND CHARACTER SIZING, INCLUDING COMPRESSION AND SPACING SIZES USED TO CREATE READABLE

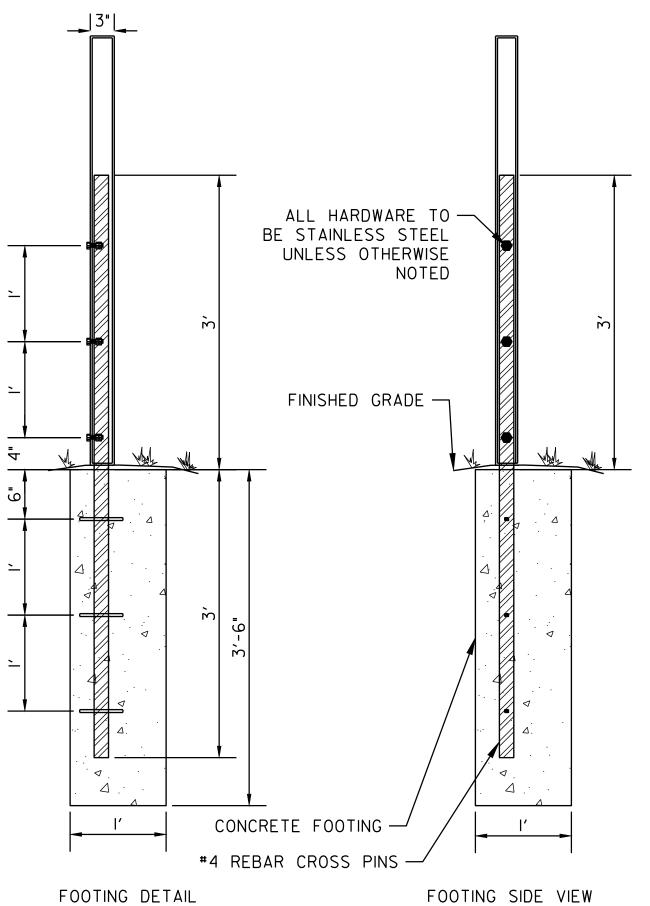

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& Stone

CAMPUS CIRCULATION IMPROVEMENTS



Project No.

Issued 03/08/2017 - BID


Revised




C-900

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PHASING DIAGRAM DETECTION LEGEND


←	DETECTED MOVEMENT
←	UNDETECTED MOVEMENT
◀	UNSIGNALIZED MOVEMENT
≪	PEDESTRIAN MOVEMENT

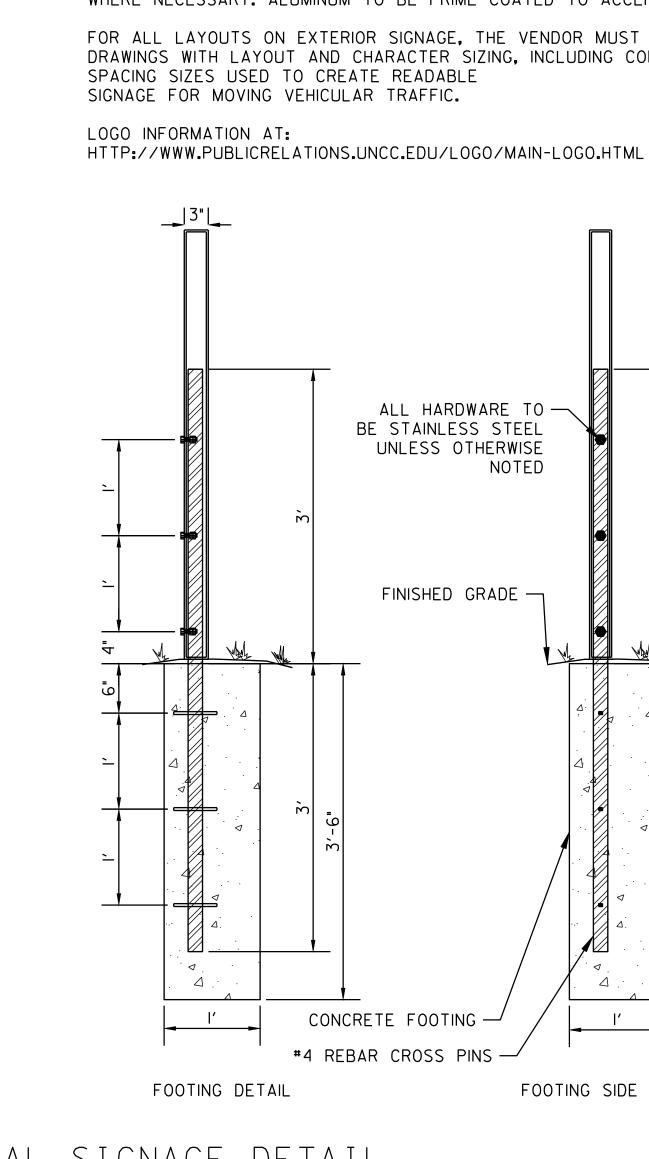TABLE OF OPERATION SIGNAL FACE 21, 22 61, 62 P41, P42 P81, P82 DW W DR

<u>SIGNAL F</u>	ACE I.D.
All Head	ds L.E.D.
R Y 12"	16
21, 22	P41, P42
61, 62	P81, P82
(BID ALT #5)	(BID ALT #5)

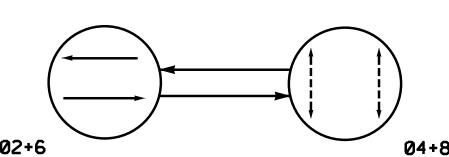(BID ALT #5)

SEE ELECT BE APPROV CONSTRUCT (BID ALT.	PEDESTRIAN SIGNALIZATION (TYP.) RICAL PLAN FINAL LOCATION TO YED BY UNC CHARLOTTE TION MANAGER #5) APPROXIMATE LOCATION OF CATS PEDESTRIAN LIGHTS. CATS PEDESTRIAN LIGHTS TO BE RELOCATED BY OTHERS PRIOR TO INSTALLATION OF SIGNAL POLES, FINAL LOCATION ON CATS SITE TO BE DETERMINED.		LIGHTS. CATS PER	
CAMERON OF FH	BOULEVARD	P42 P8 N N N N N N N N N N N N N N N N N N		CAMERON BOULEVARD
M □WM □ ECB EMH □		P41 à P82		TMH
0				
X		Existing Building		© ECB
■ DI			AC	© 6M 20 10 0 20 40 SCALE: 1" = 20'

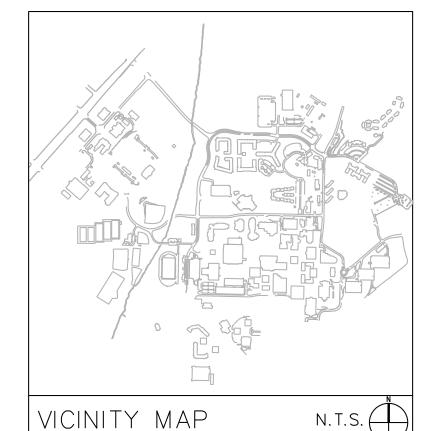

VICINITY MAP

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NOTES

1. Refer to "Roadway Standard Drawings NCDOT" dated January 2012 and "Standard Specifications for Roads and Structures" dated January 2012.

Vendors - Signal Head, Vehicular MoboTrex Inc. Econolite Control Products General Traffic Equipment Corp. McCain Traffic Supply or Approved Equal

Vendors - Signal Head, Pedestrian MoboTrex Inc. Econolite Control Products General Traffic Equipment Corp. McCain Traffic Supply or Approved Equal

2. Do not program signal for late night flashing operation unless otherwise directed by the Engineer.

3. Omit "WALK" and flashing "DON'T WALK" with no pedestrian calls.

4. Program pedestrian heads to countdown the flashing "Don't Walk" time only. 5. Pedestrian pedestals are conceptual and shown for reference only. See NCDOT special detail sheets 1705D01 for pushbutton location details. 6. All signal equipment shall be dark green "black

APPLICABLE NCDOT STANDARD DETAILS

green" in color per UNCC Design Standards.

STD.NO. TITLE

1700.01 Electrical Service Options 1700.02 Electrical Service Grounding

1705.02 Signal Heads 1705.03 Signal Heads

1715.01 Underground Conduit-Trenching

1716.01 Junction Boxes 1743.02 Pedestals

1743.04 Pedestals

ALSO SEE SHEET E-200


1751.01 Controllers and Cabinets 1751.02 Controllers and Cabinets

UNC-CHARLOTTE

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CAMPUS CIRCULATION IMPROVEMENTS



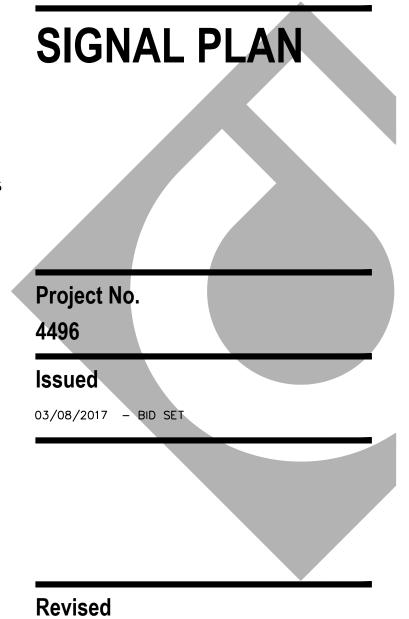

	LEGEND	
PROPOSED		EXISTING
\bigcirc	Traffic Signal Head with Type II Signal Pedestal	N/A
\downarrow	Pedestrian Signal Head With Push Button & Sign	N/A
	Controller & Cabinet	N/A
	Junction Box	N/A
	2-in Underground Conduit	N/A
\longrightarrow	Directional Arrow	\longrightarrow



C-901 **ADD ALTERNATE #5**

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	TIMIN	G CHAR	Т			
	PHASE					
FEATURE	2	4	6	8		
Min Green 1 *	-	-	-	-		
Extension 1 *	-	-	-	-		
Max Green 1 *	-	-	-	-		
Yellow Clearance	-	-	-	-		
Red Clearance	=	-	-	-		
Red Revert	-	-	-	-		
Walk 1 *	-	7	-	7		
Don't Walk 1	-	13	-	13		
Seconds Per Actuation *	-	-	-	-		
Max Variable Initial *	-	-	-	-		
Time Before Reduction *	-	-	-	-		
Time To Reduce *	-	-	-	-		
Minimum Gap	_	-	-	_		
		+				

* These values may be field adjusted. Do not adjust Min Green and Extension times for phases 2 and 6 lower than what is shown. Min Green for all other phases should not be lower than 4 seconds.

Recall Mode

Dual Entry

Vehicle Call Memory

Simultaneous Gap

PRE-BID MEETING SIGN-IN SHEET



Project: UNC Charlotte – Campus Circulation Improvements

Facilitator: ColeJenest & Stone / UNC Charlotte

Meeting Date: March 15, 2017

Place/Room: Cone Center 112A

Name	Company	Phone	E-Mail
SUPE FREZUER	CJS	704.376.1555	streyler e colejeneststone.com
ANNA WALKER	CJS) in [1]	awalker "
TODO FISHER	L JS	ly	+Fisher"
Mary Not. Fencion	LITTLE MOUNTAIN BUILDES	704.400.560	1. It lentablar D'AHOO. com
Victor ARIZA	ARMEN CONSTRUCTION		armencontractors@aol.com.
Elitabeth Frere	UNCCharloffe	704.687.0558	efrere@uncc.edu
DOROTHY VICK	UNC CHARLOTTE	704-687-0527	divick@ uncc.edu
CIRIS Cook	SIME ONE	336 688-8103	(COOSE SITEONE, COM

NOTICE TO BIDDERS

Sealed proposals will be received by The University of North Carolina in Charlotte, NC, in Room 119 of the Facilities Management & Police building (#55 on the campus map – http://facilities.uncc.edu/maps) until 2:00 pm on Tuesday, April 4, 2017 and immediately thereafter publicly opened and read for the furnishing of labor, material and equipment entering into the construction of:

Campus Circulation Improvements The University of North Carolina at Charlotte

Campus Circulation Improvements are intended to enhance pedestrian and vehicular circulation on the UNC Charlotte campus with new connection to the CATS Lynx light rail line. Work includes the installation of new brick paver sidewalks, bus drop-off with parking, raised crosswalk with pedestrian signalization, and associated wall, stair, planter, drainage, and landscape improvements.

Bids will be received for single prime contract. All proposals shall be lump sum.

Visitor parking is available in Lot 26. Visitors will need to obtain a parking pass from the FM reception area on the first floor and return to their car prior to the bid opening. Campus map is available for review at http://maps.uncc.edu/.

Non-Mandatory Pre-Bid Meeting

A **non-mandatory** pre-bid meeting will be held for all interested bidders on Wednesday, March 15, 2017 at 2:00 pm in Room 112A of the Cone University Center (#5 on the campus map). The meeting will address project specific questions, issues, bidding procedures, and bid forms. After the prebid meeting there will be a site visit to go over the project scope and locations. **This will be the only opportunity for contractors and their subcontractors to visit the site, so please have all interested parties in attendance.**

Visitor parking is located in the Cone Deck adjacent the Cone University Center.

The meeting will address project specific questions, issues, bidding procedures, and bid forms. The meeting is also to identify preferred brand alternates and their performance standards that the Owner will consider for approval on this project. A walk of the site will be conducted immediately following the meeting.

The meeting is also to identify preferred brand alternates and their performance standards that the owner will consider for approval on this project.

In accordance with General Statute GS 133-3, Specifications may list one or more preferred brands as an alternate to the base bid in limited circumstances. Specifications containing a

NOTICE TO BIDDERS PAGE 1 OF 4

preferred brand alternate under this section must identify the performance standards that support the preference. Performance standards for the preference must be approved in advance by the owner in an open meeting. Any alternate approved by the owner shall be approved only where (i) the preferred alternate will provide cost savings, maintain or improve the functioning of any process or system affected by the preferred item or items, or both, and (ii) a justification identifying these criteria is made available in writing to the public.

In accordance with GS133-3 and SCO procedures the following preferred brand items are being considered as Alternates by the owner for this project:

- A. Face Brick: "Morrocroft Special" #02-79-1 manufactured by Forterra Brick.
- B. Brick Pavers (Pedestrian, Vehicular, and ADA): Pine Hall Brick Company.

Justification of any approvals will be made available to the public in writing no later than seven (7) days prior to bid date.

Bidders questions will be entertained in writing until 5:00 pm on Wednesday, March 22, 2017. Address all questions to the designer, ColeJenest & Stone - Attn: Susan G. Freyler, sfreyler@colejeneststone.com.

Final addenda will be issued Tuesday, March 28, 2017 to all plan holders/bidders of record.

Complete plans, specifications, and contract documents will be open for inspection at:

ColeJenest & Stone
200 South Tryon Street, Suite 1400
Charlotte, NC 28202
(704) 376-1555

UNC Charlotte

Hickory Hall Room 02E – Capital Projects Design Plan Review Charlotte, NC 28223 (704) 687-0615

Metrolina Minority Contractors Association (MMCA) Plan Room 2848 Queen City Drive, Suite B Charlotte, NC 28208 (877) 526-6205 mmca@mmcaofcharlotte.org

Or may be obtained from <u>ColeJenest & Stone</u>, upon deposit of fifty dollars (\$50) in cash or certified check. The full plan deposit will be returned to those bidders provided all documents are returned in good, usable condition within ten (10) days after the bid date.

NOTICE TO BIDDERS PAGE 2 OF 4

Electronic copies of the plans, specifications and contract documents will also be provided electronically to all interested bidders. Contact for electronic plans and specifications is Susan Freyler at (704) 376-1555 or sfreyler@colejeneststone.com.

Electronic copies of the plans, specifications and contract documents are available at the following:

- 1. Construct Connect at content@constructconnect.com 800-364-2059.
- 2. North Carolina Offices of McGraw-Hill Dodge Corporation (877) 784-9556 or (800) 393-6343; http://construction.com/dodge
- 3. Metrolina Minority Contractors Association (877) 526-6205; mmca@mmcaofcharlotte.org

NOTE: The bidder shall include <u>with the bid proposal</u> the form <u>Identification of Minority Business Participation</u> identifying the minority business participation it will use on the project <u>and</u> shall include either <u>Affidavit **A**</u> or <u>Affidavit **B**</u> as applicable. Forms and instructions are included within the Proposal Form in the bid documents. Failure to complete these forms is grounds for rejection of the bid. (GS143-128.2c Effective 1/1/2002.)

All contractors are hereby notified that they must have proper license as required under the state laws governing their respective trades.

General contractors are notified that Chapter 87, Article 1, General Statutes of North Carolina, will be observed in receiving and awarding general contracts. General contractors submitting bids on this project must have license classification for <u>Building Contractor with an unlimited</u> license required by the NC General Contractors Licensing Board under G.S. 87-1.

NOTE--SINGLE PRIME CONTRACTS: Under GS 87-1, a contractor that superintends or manages construction of any building, highway, public utility, grading, structure or improvement shall be deemed a "general contractor" and shall be so licensed. Therefore a single prime project that involves other trades will require the single prime contractor to hold a proper General Contractors license.

Each proposal shall be accompanied by a cash deposit or a certified check drawn on some bank or trust company, insured by the Federal Deposit Insurance Corporation, of an amount equal to not less than five percent (5%) of the proposal, or in lieu thereof a bidder may offer a bid bond of five percent (5%) of the bid executed by a surety company licensed under the laws of North Carolina to execute the contract in accordance with the bid bond. Said deposit shall be retained by the owner as liquidated damages in event of failure of the successful bidder to execute the contract within ten days after the award or to give satisfactory surety as required by law.

A performance and payment bond will be required for one hundred percent (100%) of the contract price.

NOTICE TO BIDDERS PAGE 3 OF 4

Payment will be made based on ninety-five percent (95%) of monthly estimates and final payment made upon completion and acceptance of work.

No bid may be withdrawn after the scheduled closing time for the receipt of bids for a period of 30 days.

The owner reserves the right to reject any or all bids and to waive informalities.

Bidders who will not attend the Bid Opening need to ensure their sealed bids are delivered no later than 1:00 pm on Tuesday, April 4, 2017 to the following:

Mailed Proposals:

Attn: Ms. Joyce Clay, Hickory Hall, Room 35B The University of North Carolina at Charlotte Facilities Management – Capital Projects 9201 University City Boulevard Charlotte, NC 28223-0001

Or

Hand Delivered:

Attn: Ms. Joyce Clay – Capital Projects, Room 35B Hickory Hall (#536 on the campus map) Charlotte, NC 28223 (704) 687-0615

Designer:

ColeJenest & Stone 200 South Tryon Street, Suite 1400 Charlotte, NC 28202 (704) 376-1555

Owner:

The University of North Carolina at Charlotte Hickory Hall, FM - Capital Projects 9201 University City Blvd Charlotte, NC 28223 (704) 687-0615

NOTICE TO BIDDERS PAGE 4 OF 4

STATE OF NORTH CAROLINA STANDARD FORM OF PROPOSAL

FOR

The University of North Carolina at Charlotte Campus Circulation Improvements Charlotte, NC SCO# 16-14055 Code 41526, Item 310

BID/ACCEPTANCE FORM

for

Campus Circulation Improvements

The project scope includes the pedestrian and vehicular Improvements for the UNC Charlotte Campus including new sidewalks, bus drop-off, raised pedestrian crosswalk, signalized intersection and other landscape and hardscape improvements. The improvements are located at Wallis Hall, across from the Main Station, Cameron Blvd., Student Union and the J.W. Clay Station on the campus of the University of North Carolina at Charlotte.

The undersigned, as bidder, proposes and agrees if this bid is accepted to contract with the State of North Carolina through the University of North Carolina at Charlotte for the furnishing of all materials, equipment, and labor necessary to complete the construction of the work described in these documents in full and complete accordance with plans, specifications, and contract documents, and to the full and entire satisfaction of the University of North Carolina at Charlotte and ColeJenest & Stone, P.A. for the sum of:

BASE BID: Dollars \$

Add Alternate #	Add Alternate Bid Price	Accepted (OWNER INITIALS)
1 Cameron Boulevard Project Area Improvements		
2 Student Union Project Area Improvements		
3 Brick Seal Paving Pattern in Sidewalk		
4 Add Bus Drop-off and widen sidewalk at the Main Station		
5 Add Signalized Intersection at the Main Station		
6A Landscape at Main Station		
6B Landscape at Main Station – ALT #4		
6C Landscape at J.W. Clay Station		
7 8' Brick Sidewalk at J.W. Clay Station		
8 6' Decorative Aluminum Fence at J.W. Clay Station		
9 Preferred Brand – Face Brick (Forterra Brick)		
10 Preferred Brand – Paver Brick (Pine Hall Brick Company)		

UNIT PRICES

Unit prices quoted and accepted shall apply throughout the life of the contract, except as otherwise specifically noted.	Unit prices
shall be applied, as appropriate, to compute the total value of changes in the base bid quantity of the work, all in accor	dance with
the contract documents.	

Jnit Price A – Unsatisfactory Soil		\$	/C.Y.
Init Price B – Trench Rock		\$	/C.Y.
Init Price C – Pedestrian Brick Paver Sidewalk		\$	/S.F.
Jnit Price D – Vehicular Brick Paver		\$	/S.F.
Jnit Price E – Sod		\$	/S.F.
Jnit Price F – Decorative Fence		\$	/L.F.
Addendum received and used in computing b	bid:		
Addendum No. 1			
Addendum No. 2			
Addendum No. 3			
Addendum No. 4			
Respectively submitted thisc	day of		20
	(Contractor's Na		
ederal ID#:	By <u>:</u>		
Vitness:	Title:		
	(Owner, pa	artner, corp. Pres. Or Vice	,
Proprietorship or Partnership)	Address <u>:</u>		
attest: (corporation)	Email Addı	ess:	
(Corporate Seal)			
(Gorporate Godi)			
sy:		License #:	
itle:			
itle:(Corporation, Secretary./Ass't Secretary.)			
ACCEPTED by the S	STATE OF NO	ORTH CAROLI	[NA
	ersity of North Caroli		
otal amount of accepted by the owner, included	base bid and bid all	ernates:	
	(Agency/Institution)		
·V·		TITI C.	

SECTION 01 23 00 - ALTERNATES

PART 1 - GENERAL

1.1 SUMMARY

A. Section includes administrative and procedural requirements for alternates.

1.2 DEFINITIONS

- A. Alternate: An amount proposed by bidders and stated on the Bid Form for certain work defined in the bidding requirements that may be added to or deducted from the base bid amount if Owner decides to accept a corresponding change either in the amount of construction to be completed or in the products, materials, equipment, systems, or installation methods described in the Contract Documents.
 - 1. Alternates described in this Section are part of the Work only if enumerated in the Agreement.
 - 2. The cost or credit for each alternate is the net addition to or deduction from the Contract Sum to incorporate alternate into the Work. No other adjustments are made to the Contract Sum.

1.3 PROCEDURES

- A. Coordination: Revise or adjust affected adjacent work as necessary to completely integrate work of the alternate into Project.
 - 1. Include as part of each alternate, miscellaneous devices, accessory objects, and similar items incidental to or required for a complete installation whether or not indicated as part of alternate.
- B. Notification: Immediately following award of the Contract, notify each party involved, in writing, of the status of each alternate. Indicate if alternates have been accepted, rejected, or deferred for later consideration. Include a complete description of negotiated revisions to alternates.
- C. Execute accepted alternates under the same conditions as other work of the Contract.
- D. Schedule: A schedule of alternates is included at the end of this Section. Specification Sections referenced in schedule contain requirements for materials necessary to achieve the work described under each alternate.

ALTERNATES 01 23 00 - 1

PART 2 - PRODUCTS (Not Used)

PART 3 - EXECUTION

3.1 SCHEDULE OF ALTERNATES


- A. Alternate No.1: Cameron Boulevard Project Area Improvements
 - 1. Description: Work to include the expansion and extension of brick sidewalks, crosswalks, parking lot modifications, retaining walls, and storm drainage additions and modifications, as noted on the plans.
 - 2. Base Bid: No work.
 - 3. Alternate: All work shown on drawings.
- B. Alternate No.2 : Student Union Project Area Improvements.
 - 1. Description: Work to include the expansion and extension of brick sidewalks, stairs, retaining walls, railings as noted on the plans.
 - 2. Base Bid: No work.
 - 3. Alternate: All work shown on drawings.
- C. Alternate No.3: Brick Seal Paving Pattern in Sidewalk
 - 1. Description: Work to include the construction of the brick UNC Charlotte seal paving pattern at Wallis Hall.
 - 2. Base Bid: herringbone field
 - 3. Alternate: addition of seal pattern
- D. Alternate No. 4: Add Bus Drop-off and widen sidewalk at the Main Station
 - 1. Description: Work to include adding heavy-duty concrete paving, widening existing brick walk to 8', adding additional curb and gutter, removal of trees, new emergency blue light and additional pedestrian light relocations. Not including landscape; landscape is priced under Alternate 6B.
 - 2. Base bid: As described on drawings.
 - 3. Alternate: As described on drawings.
- E. Alternate No.5: Add Signalized Intersection at the Main Station
 - 1. Description: Work to include adding the pedestrian and traffic signal poles, bases, electrical boxes and panels, wiring and signal heads.
 - 2. Base Bid: Install conduit for the wiring only (including the caps for the conduit and pull strings) as indicated on drawings.
 - 3. Alternate: Complete signal system.
- F. Alternate 6A: Landscape at Main Station
 - 1. Description: Work will include installation of proposed plant material (plants and sod) to be located in existing and proposed planting beds in front of Wallis Hall. Additionally, two (2) street trees are to be installed along Cameron Blvd., in front of Wallis Hall.
 - 2. Base Bid: Planting bed and soil preparation/topsoil installation per Specification 329200 and 329300, with seed and mulch only.
 - 3. Alternate: Complete landscape per drawings.


ALTERNATES 01 23 00 - 2


- G. Alternate 6B: Landscape at Main Station ALT #4
 - 1. Description: Work will include installation of proposed plant material (plants and sod) to be located in existing and proposed planting beds in front of Wallis Hall. Additionally, sod for all disturbed areas as part of Alternate #4, three (3) street trees, and five (5) evergreen trees are to be installed along Cameron Blvd., in front of Wallis Hall.
 - 2. Base Bid: Planting bed and soil preparation/topsoil installation per Specification 329200 and 329300, with seed and mulch only.
 - 3. Alternate: Complete landscape per drawings.
- H. Alternate 6C: Landscape at J.W. Clay Station
 - 1. Description: Work will include installation of sod between existing back of curb on JW Clay Blvd. and edge of sidewalk.
 - 2. Base Bid: Planting bed and soil preparation/topsoil installation per Specification 329200 and 329300, with seed and mulch only.
 - 3. Alternate: Complete landscape per drawings.
- I. Alternate No.7: 8' Brick Sidewalk at J.W. Clay Station
 - 1. Description: Work to include adding the 8' brick sidewalk in lieu of the 8' concrete sidewalk. See Sheet C-203 and Details 1-3 on Sheet C-800.
 - 2. Base Bid: Concrete walk.
 - 3. Alternate: Brick walk per drawings.
- J. Alternate No.8: 6' Decorative Aluminum Fence at J.W. Clay Station
 - 1. Description: Work to include adding aluminum fencing as shown on Sheet C-203 and on Detail 1 on Sheet C-802.
 - 2. Base Bid: No fence.
 - 3. Alternate: Install fence per drawings.
- K. Preferred Brand Alternate No.9: Face Brick
 - 1. Description: Utilize Owner's preferred brand: "Morrocroft Special" #02-79-1 manufactured by Forterra Brick for all face brick per Specification 042000.
- L. Preferred Brand Alternate No.10: Paver Brick
 - 1. Description: Utilize Owner's preferred brand: "Pine Hall Brick Company" for all paver brick (pedestrian, vehicular and ADA) per Specification 321400.

END OF SECTION

ALTERNATES 01 23 00 - 3

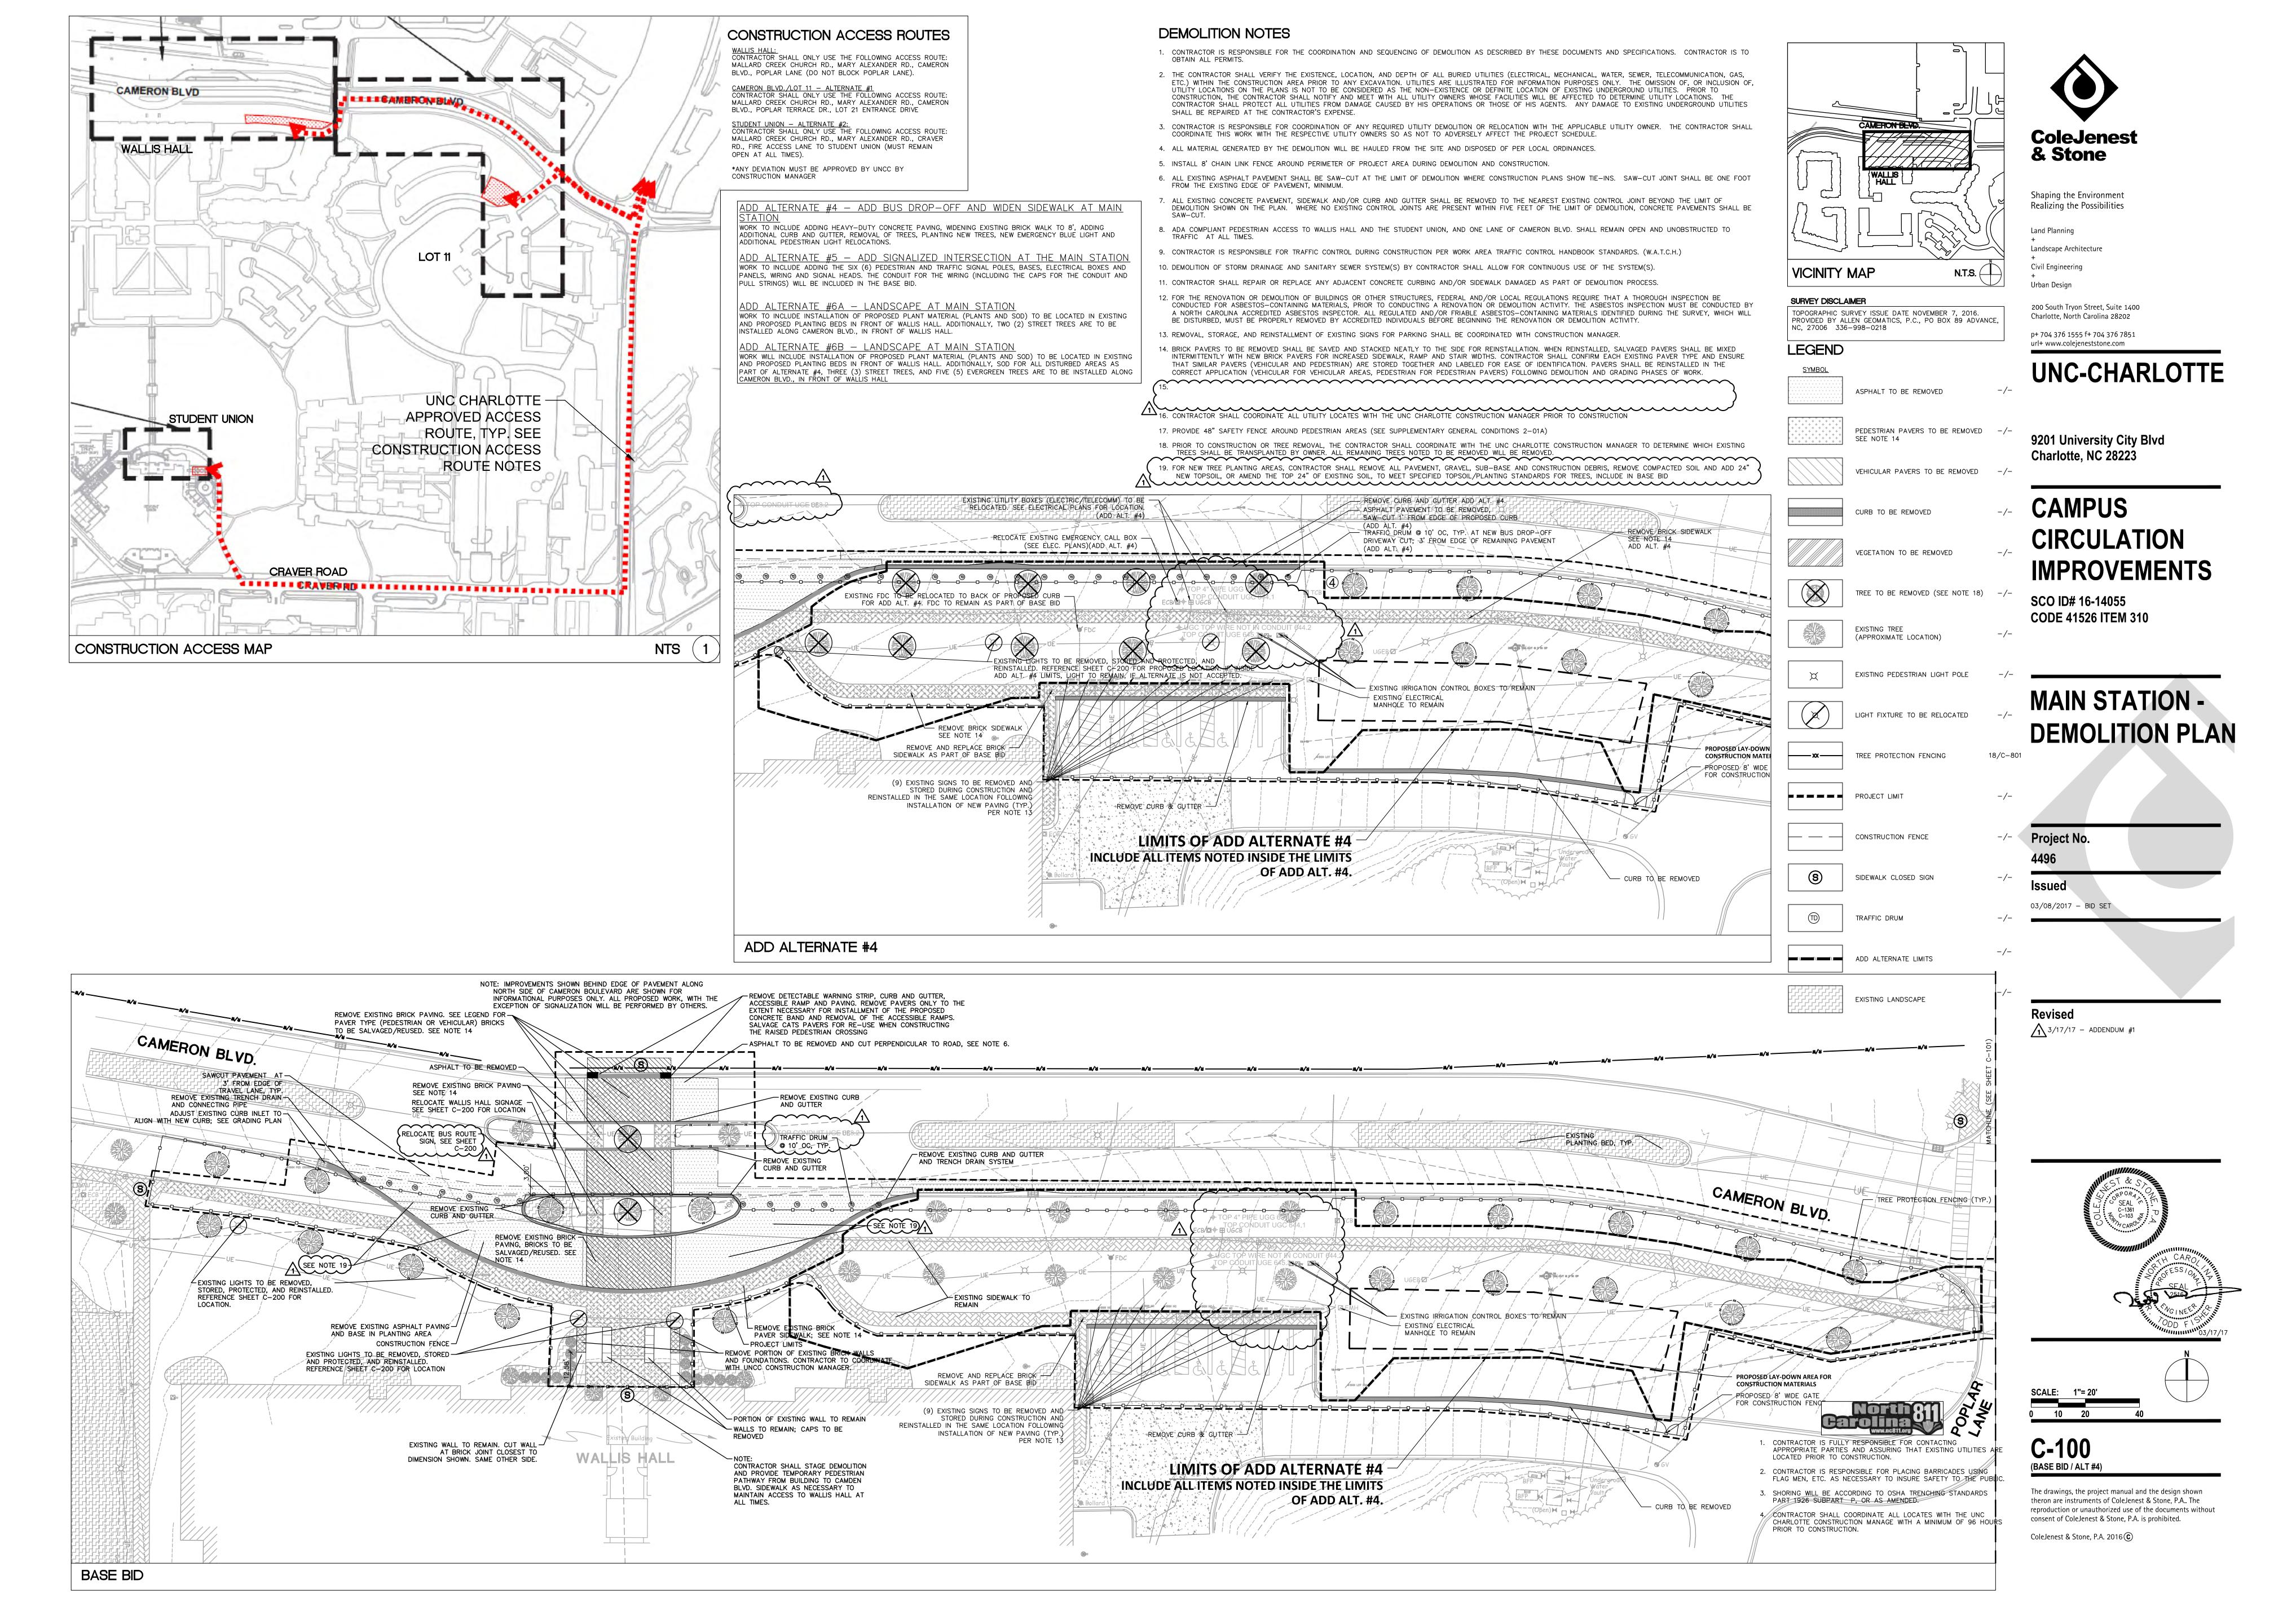


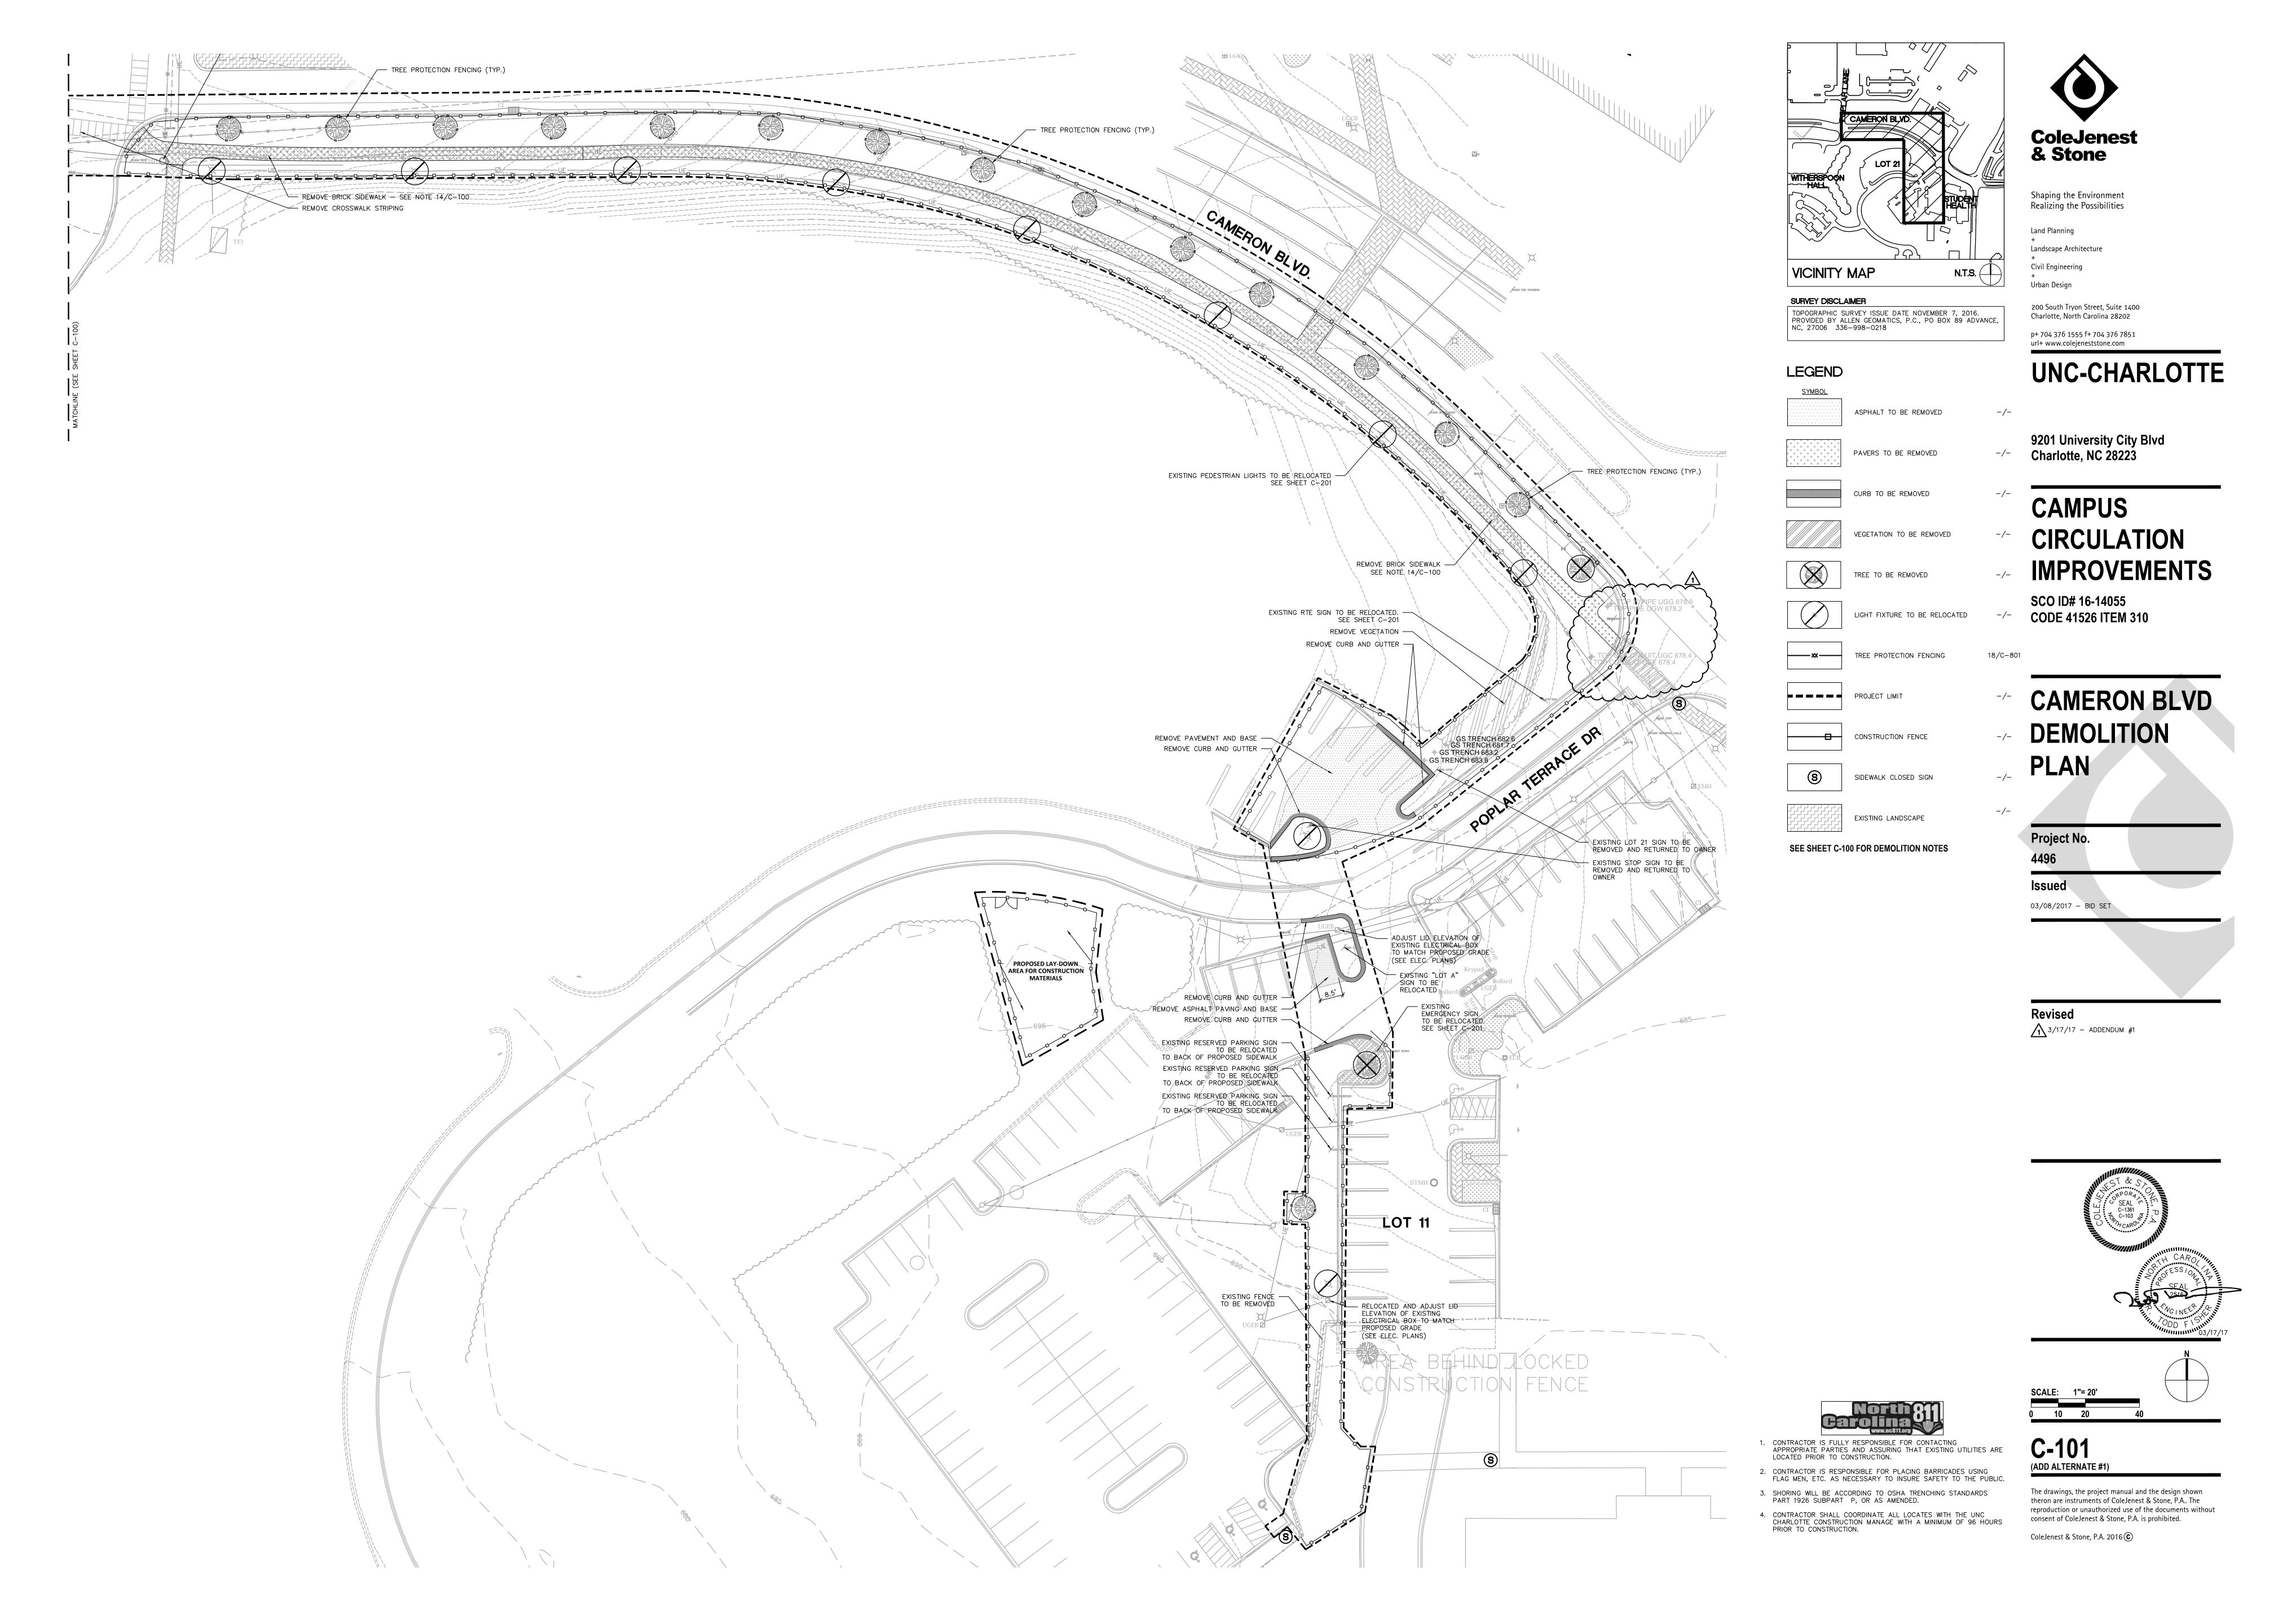

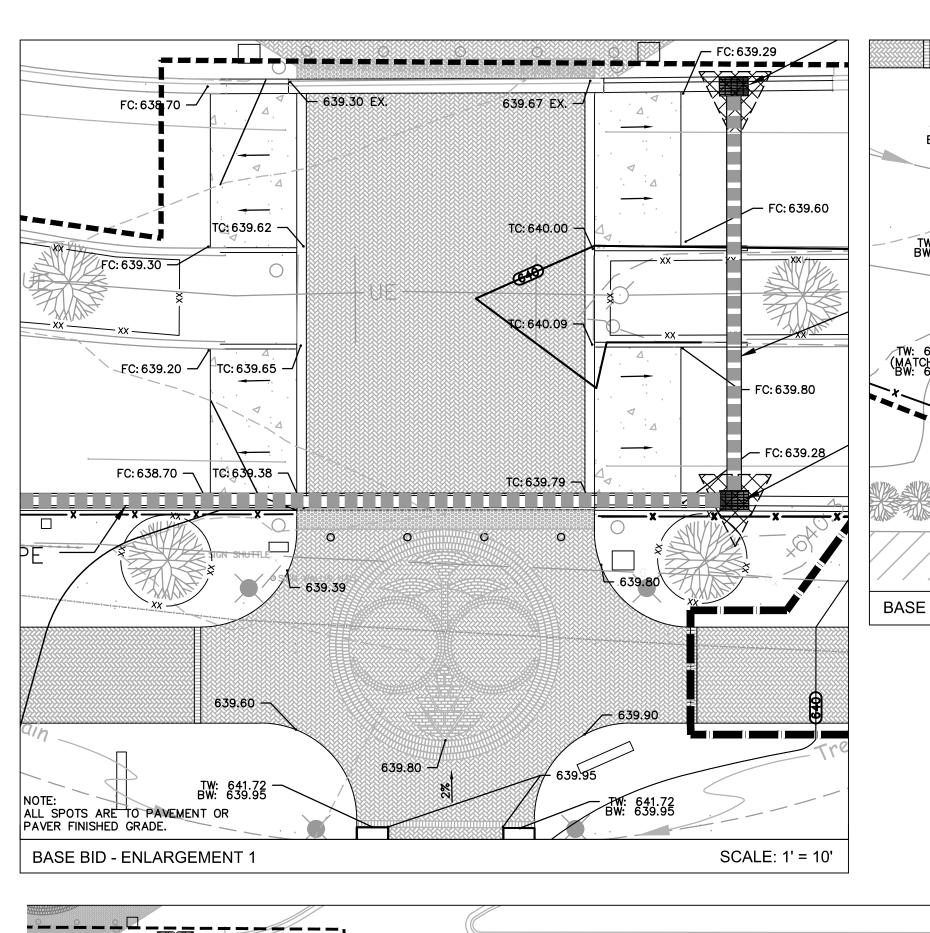


ACROSS DRIVEWAY

Building

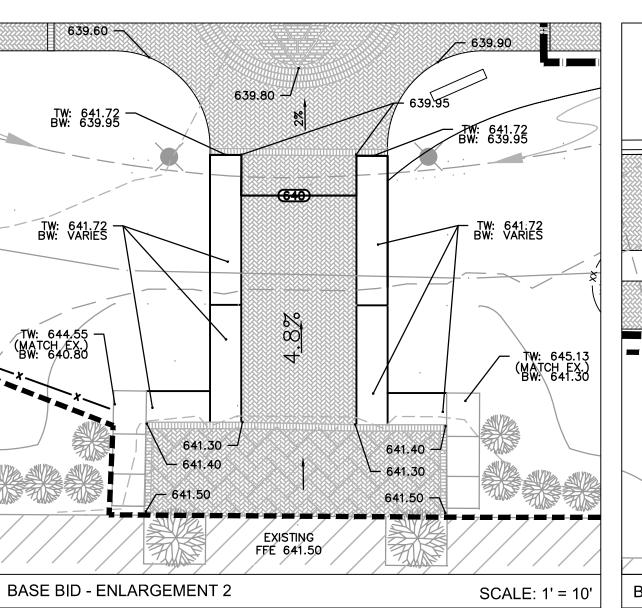

- AREA LIMITS OF ALTERNATE

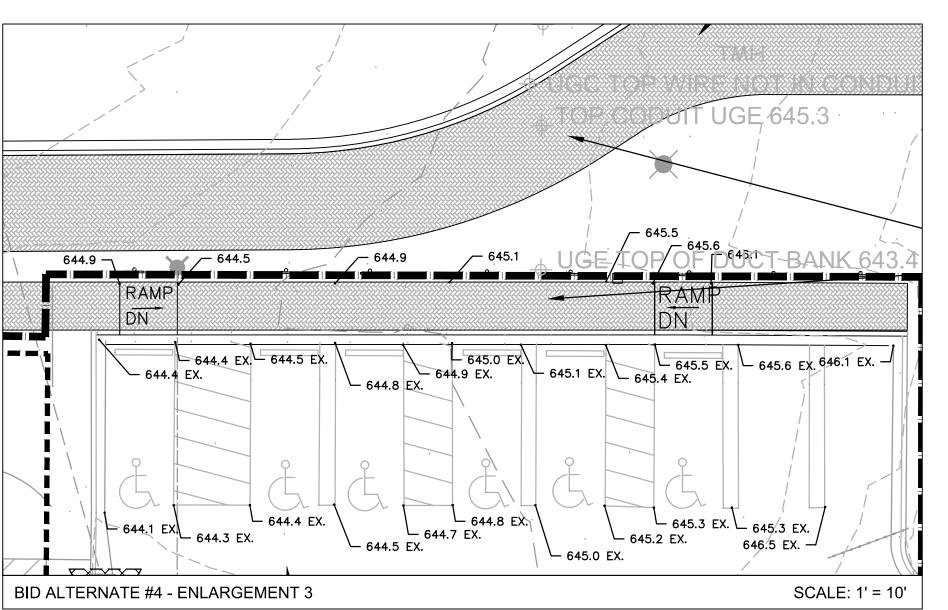


ADJUST EXISTING ELECTRICAL AND TELECOMMUNICATION CONTROL BOX LIDS TO PROPOSED GRADE. ENLARGEMENT 3

GRADING AND EARTHWORK NOTES

- 1. REFER TO THE UNIVERSITY OF NORTH CAROLINA AT CHARLOTTE DESIGN AND CONSTRUCTION MANUAL, DIVISION 31 FOR ALL EARTHWORK CONSTRUCTION GUIDELINES. 2. ON-SITE BURIAL PITS REQUIRE A PERMIT.
- 3. ANY GRADING BEYOND THE DENUDED LIMITS INDICATED ON THE CONSTRUCTION DOCUMENTS IS A VIOLATION OF EROSION CONTROL ORDINANCES AND IS SUBJECT TO A
- 4. GRADING MORE THAN ONE ACRE WITHOUT AN APPROVED EROSION CONTROL PLAN IS A VIOLATION OF EROSION CONTROL ORDINANCES AND IS SUBJECT TO A FINE.
- . APPROVAL OF THIS PLAN IS NOT AN AUTHORIZATION TO GRADE ON ADJACENT PROPERTIES. WHEN FIELD CONDITIONS WARRANT OFF-SITE GRADING, PERMISSION MUST BE OBTAINED FROM THE AFFECTED PROPERTY OWNER(S).
- 5. THE CONTRACTOR SHALL IMMEDIATELY REPORT TO OWNER ANY DISCREPANCIES FOUND BETWEEN ACTUAL FIELD CONDITIONS AND CONSTRUCTION DOCUMENTS AND SHALL WAIT FOR INSTRUCTION PRIOR TO PROCEEDING.
- 7. CONTRACTOR SHALL VERIFY LOCATION OF ALL EXISTING UTILITIES IN THE FIELD PRIOR TO BEGINNING CONSTRUCTION. 8. LIMITS OF CLEARING SHOWN ON GRADING PLAN ARE BASED UPON THE APPROXIMATE
- CUT AND FILL SLOPE LIMITS, OR OTHER GRADING REQUIREMENTS. 9. ALL ELEVATIONS ARE IN REFERENCE TO THE SITE BENCHMARK. CONTRACTOR SHALL VERIFY THE BENCHMARK PRIOR TO GROUND BREAKING.
- 10. THE PROPOSED CONTOURS AND SPOT ELEVATIONS SHOWN WITHIN ROADWAYS, PARKING LOTS, AND SIDEWALK AREAS REFLECT FINISHED ELEVATIONS INCLUDING PAVEMENT. REFER TO PAVEMENT CROSS SECTION DATA TO ESTABLISH CORRECT SUBBASE OR AGGREGATE BASE COURSE ELEVATIONS TO BE COMPLETED UNDER THIS CONTRACT.
- 11. GRADES SHALL BE ESTABLISHED TO PROVIDE A SMOOTH SURFACE, FREE FROM IRREGULAR SURFACE CHANGES. GRADING SHALL COMPLY WITH COMPACTION REQUIREMENTS AND GRADE CROSS SECTIONS, LINES, AND ELEVATIONS INDICATED. WHERE NO SPOT GRADES ARE INDICATED, THE GRADE SHALL BE ESTABLISHED BASED ON INTERPOLATION OF THE ELEVATIONS BETWEEN ADJACENT SPOT GRADES WHILE MAINTAINING APPROPRIATE TRANSITION AT STRUCTURES AND PAVING, AND UNINTERRUPTED DRAINAGE FLOW INTO INLETS.
- 12. CONTRACTOR SHALL ENSURE POSITIVE DRAINAGE SUCH THAT RUNOFF WILL DRAIN BY GRAVITY FLOW ACROSS NEW GRADED AREAS TO NEW OR EXISTING DRAINAGE INLETS, OR SHEET OVERLAND.
- 13. ALL SIDEWALKS, STOOPS, TERRACES AND OTHER PAVED AREAS SHALL SLOPE AWAY FROM BUILDING(S) AT 2.0% MAXIMUM.
- 14. COLEJENEST AND STONE, P.A., HAS NOT PERFORMED ANY GEOTECHNICAL EVALUATIONS OF THE SUBJECT PROPERTY AND HAS NOT MADE ANY DETERMINATIONS AS TO THE SUITABILITY OF SITE SOILS FOR USE AS FILL BENEATH PROPOSED BUILDINGS, DRIVEWAYS, PARKING AREAS, OR FOR OTHER USES. ALL EARTHWORK SHALL BE COMPLETED IN ACCORDANCE WITH THE RECOMMENDATIONS OF A QUALIFIED GEOTECHNICAL ENGINEER WHO SHALL BE RETAINED BY THE OWNER.
- 15. ALL FILL SHALL BE PLACED IN MAXIMUM 8-INCH LIFTS AND COMPACTED. ALL FILL WITHIN LIMITS OF BUILDING AND PAVEMENT AREAS SHALL BE COMPACTED TO 100% OF MAXIMUM STANDARD PROCTOR DENSITY WITHIN THE TOP 12 INCHES AND A MINIMUM 95% OF MAXIMUM STANDARD PROCTOR DENSITY BELOW 12-INCH DEPTH. FILL WITHIN LANDSCAPED AREAS SHALL BE COMPACTED TO MINIMUM 90% OF MAXIMUM STANDARD PROCTOR DENSITY. MAXIMUM STANDARD PROCTOR DENSITIES SHALL BE DETERMINED IN ACCORDANCE WITH ASTM D 698. REFER TO GEOTECHNICAL ENGINEER'S REPORT FOR ADDITIONAL EARTHWORK SPECIFICATIONS AND REQUIREMENTS.
- 16. FOR SLOPE CONSTRUCTION 3:1 AND STEEPER AND EXCEEDING 5 FEET IN VERTICAL HEIGHT, THE CONTRACTOR SHALL COORDINATE WITH A GEOTECHNICAL ENGINEER ON THE SUITABILITY OF SOILS PLANNED FOR THESE SLOPES AND FOLLOW RECOMMENDATIONS SET FORTH BY THE GEOTECHNICAL ENGINEER FOR SLOPE CONSTRUCTION. ALL SUCH SLOPES SHALL BE TRACKED TOP TO BOTTOM AND STABILIZED WITH A ROLLED EROSION CONTROL BLANKET CONSISTING OF POLYPROPYLENE NETTING AND A STRAW/COCONUT FIBER MATRIX, STAKED TO MANUFACTURER'S RECOMMENDATIONS. TOP SOIL PLACEMENT ON SLOPES SHALL BE INSTALLED IN A BENCHED PATTERN.
- ASTM D 698. SOIL MATERIAL THAT EXCEEDS THE OPTIMUM MOISTURE CONTENT BY 3 PERCENT OR MORE, AND IS TOO WET TO COMPACT TO THE SPECIFIED DRY UNIT WEIGHT, SHALL BE SCARIFIED AND AIR DRIED, LIME STABILIZED, OR REMOVED AND REPLACED. 19. CONTRACTOR SHALL PROVIDE ALL DEWATERING MEASURES NECESSARY, INCLUDING WELL POINTS, SUMP PUMPS, TEMPORARY SHORING, ETC., TO ENSURE COMPLETION OF STABLE EXCAVATION AND BACKFILL OPERATIONS. GROUNDWATER SHALL BE MAINTAINED A MINIMUM OF 2 FT. BELOW THE BOTTOM OF ALL EXCAVATIONS.
- OWNER SHALL ENGAGE A QUALIFIED INDEPENDENT GEOTECHNICAL ENGINEERING TESTING AGENCY TO PERFORM FIELD QUALITY CONTROL TESTING. TESTING AGENCY SHALL TEST COMPACTION OF SOILS IN PLACE ACCORDING TO ASTM D2922 AND ASTM D2937, AS APPLICABLE. TEST SHALL BE PERFORMED AT EACH COMPACTED BACKFILL LAYER AT A
- . ALL GRADED OR DISTURBED AREAS BEYOND THE LIMITS OF PAVING, SIDEWALKS,
- 23. THE TOTAL DENUDED AREA FOR ALL PROJECT AREAS IS 1.96 ACRES. THE TOTAL DENUDED AREA FOR BASE BID IS 1.32 ACRES (NON-ADJOINING).

DENUDED AREA FOR MAIN STATION WORK AREA IS 1.0 ACRES. DENUDED AREA FOR CAMERON BLVD. WORK AREA IS 0.56 ACRES.

DENUDED AREA FOR JW CLAY BLVD WORK AREA IS 0.32 ACRES. 24. SEE SHEET C-403 FOR EROSION CONTROL NOTES & CONSTRUCTION SEQUENCE.

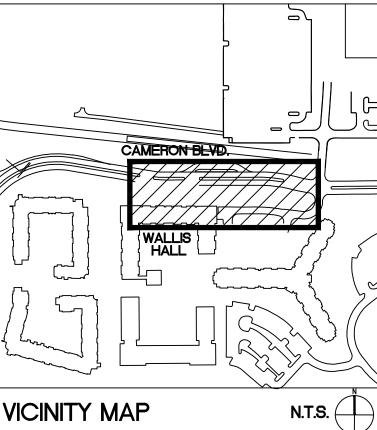

Urban Design 200 South Tryon Street, Suite 1400 TOPOGRAPHIC SURVEY ISSUE DATE NOVEMBER 7, 2016. Charlotte, North Carolina 28202 PROVIDED BY ALLEN GEOMATICS, P.C., PO BOX 89 ADVANCE,

LEGEND <u>SYMBOL</u>

NC, 27006 336-998-0218

PROPOSED CONTOUR PROPOSED INDEX CONTOUR

PROPOSED SPOT ELEVATION PROPOSED HIGH POINT

PROPOSED AREA DRAIN

TREE PROTECTION FENCING

PROPOSED CATCH BASIN

PROPOSED MANHOLE

ADD ALTERNATE LIMITS

PROJECT LIMIT

CATCH BASIN INLET PROTECTION 6/C-802

PROPOSED DRAINAGE SWALE PROPOSED STORM DRAINAGE

7. ALL PROJECT SUBGRADE SHALL BE INSPECTED BY THE GEOTECHNICAL ENGINEER. IF THE GEOTECHNICAL ENGINEER DETERMINES THAT UNSATISFACTORY SOIL IS PRESENT, THE UNSATISFACTORY MATERIAL SHALL BE REMOVED AND REPLACED WITH COMPACTED BACKFILL. SUCH ADDITIONAL AUTHORIZED EXCAVATION SHALL BE PAID FOR ACCORDING TO THE CONTRACT PROVISIONS FOR UNIT PRICES. 18. CONTRACTOR SHALL BE RESPONSIBLE FOR MAINTAINING ALL FILL AND BACKFILL


MATERIAL WITHIN 3 PERCENT OF THE OPTIMUM MOISTURE CONTENT AS DETERMINED BY

20. CONTRACTOR SHALL CONSULT WITH THE GEOTECHNICAL ENGINEER AND PROVIDE ANY AND ALL SHORING DETERMINED TO BE NECESSARY TO PROTECT EXISTING BUILDING FOUNDATIONS OR OTHER ADJACENT IMPROVEMENTS.

RATE OF NOT LESS THAN ONE TEST FOR EACH 2500 SF OF FILL AREA OR ONE TEST PER EACH 100 LF OF WALL OR TRENCH LENGTH.

BUILDINGS, ETC., THAT ARE NOT OTHERWISE LANDSCAPED PER THE LANDSCAPING PLAN, SHALL BE STABILIZED WITH A NEW LAWN SEEDED IN ACCORDANCE WITH THE SEEDING SPECIFICATION, SEE SHEET C-403. CONTRACTOR SHALL MAINTAIN SEEDED AREAS UNTIL A HEALTHY STAND OF GRASS IS ESTABLISHED.

DENUDED AREA FOR STUDENT UNION WORK AREA IS 0.08 ACRES.

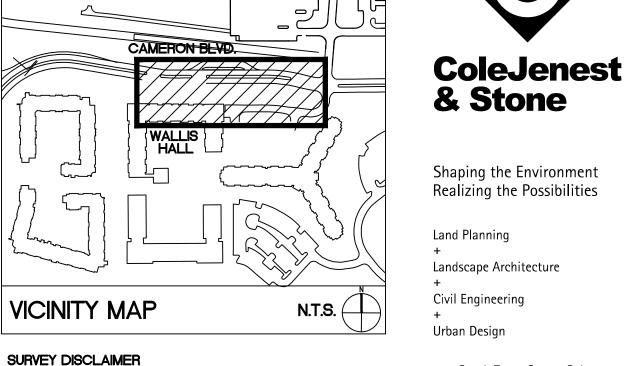

url+ www.colejeneststone.com DETAIL UNC-CHARLOTTE

9201 University City Blvd

p+ 704 376 1555 f+ 704 376 7851

Charlotte, NC 28223

CAMPUS CIRCULATION IMPROVEMENTS

SCO ID# 16-14055 **CODE 41526 ITEM 310**


MAIN STATION -GRADING, DRAINAGE AND EROSION **CONTROL PLAN**


8/C-802

^{20/C-801} **Issued**

03/08/2017 - BID SE


Revised 3/17/17 - ADDENDUM #1

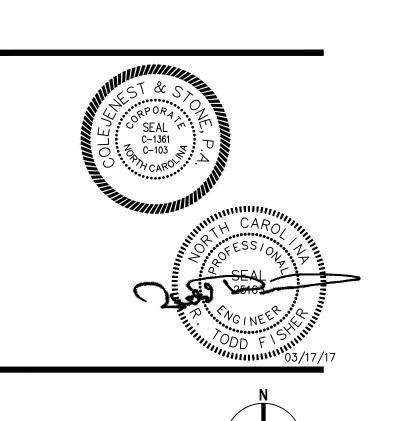

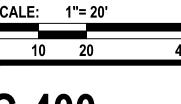

C-400 (BASE BID/ALT. #4,5)


The drawings, the project manual and the design shown theron are instruments of ColeJenest & Stone, P.A.. The reproduction or unauthorized use of the documents without consent of ColeJenest & Stone, P.A. is prohibited. ColeJenest & Stone, P.A. 2016 C

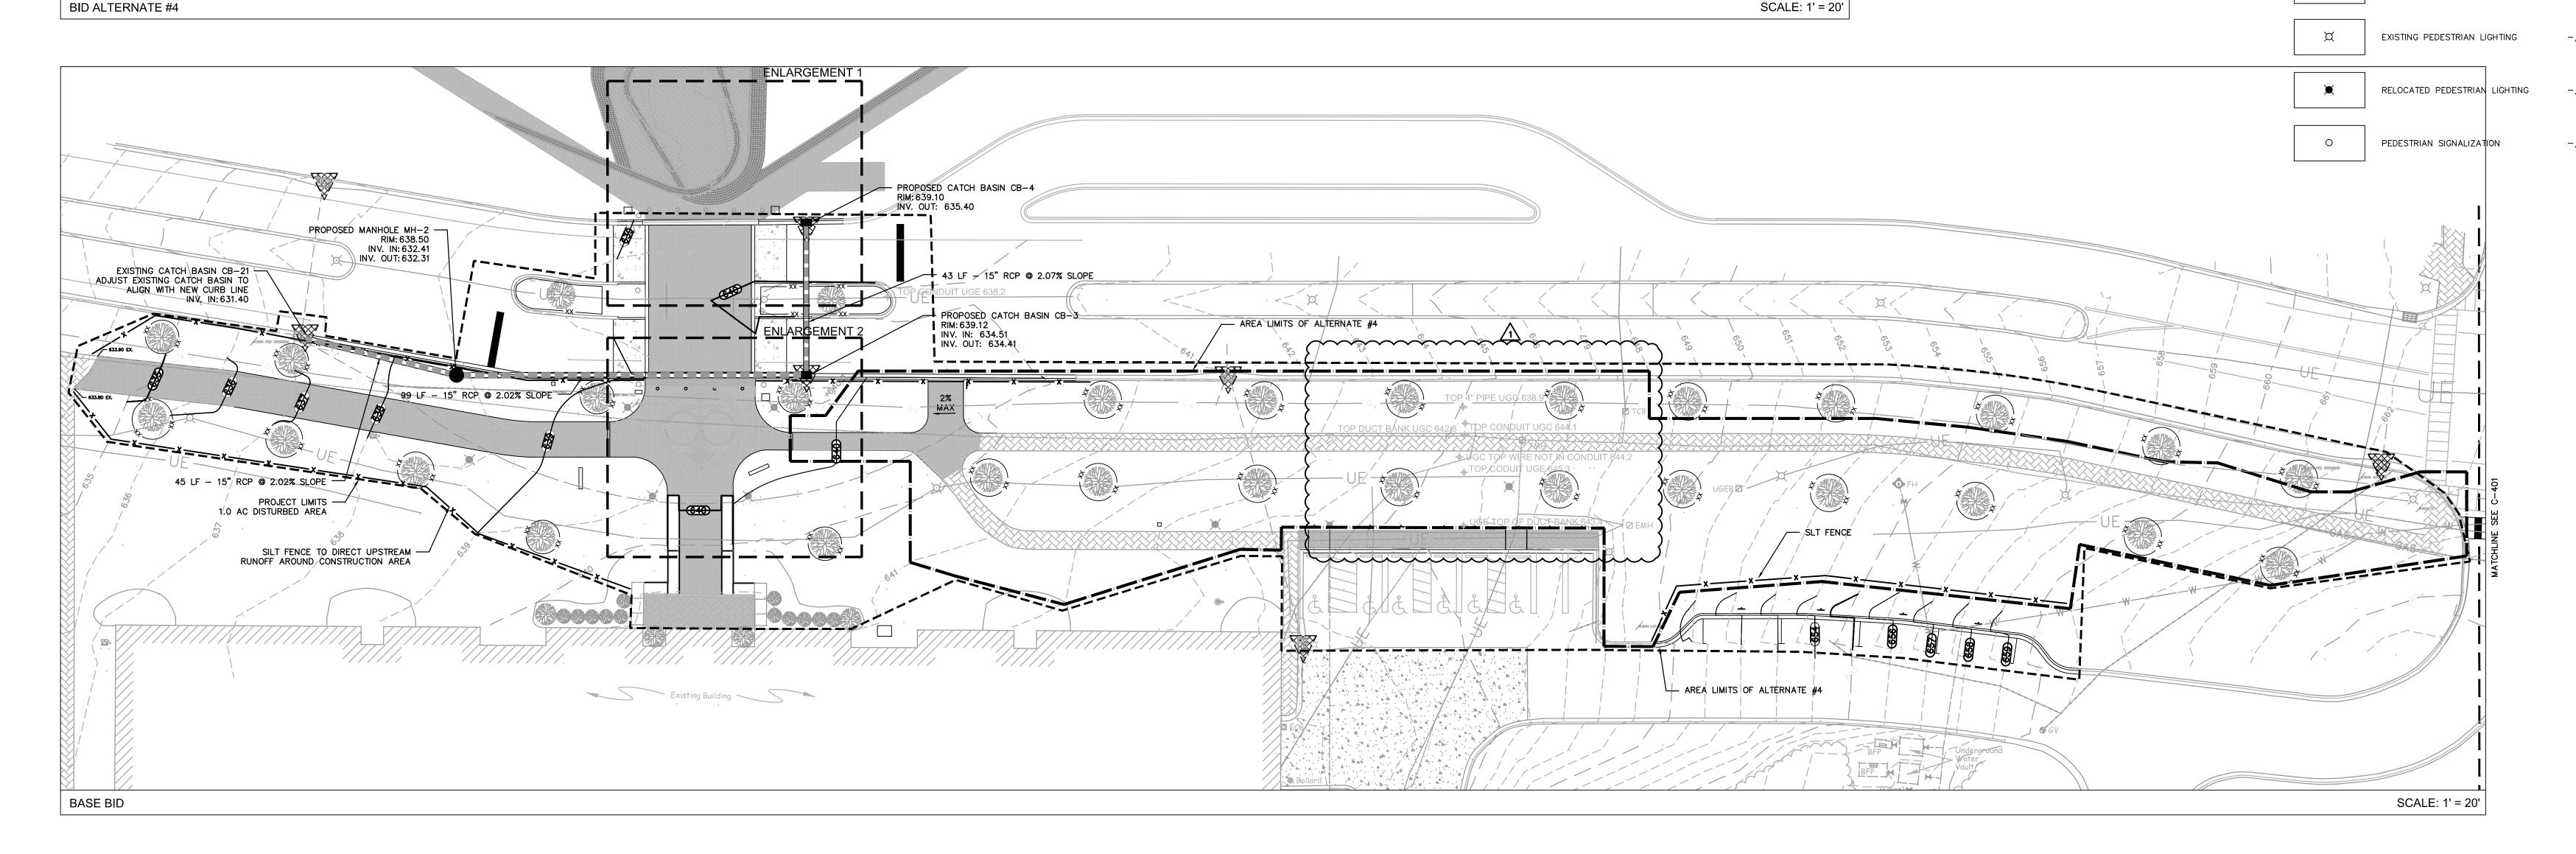

- LOCATE AND REBURY EXISTING

ELECTRICAL LINE AS NEEDED /

TO ACCOMMODATE PROPOSED PAVEMENT CONSTRUCTION

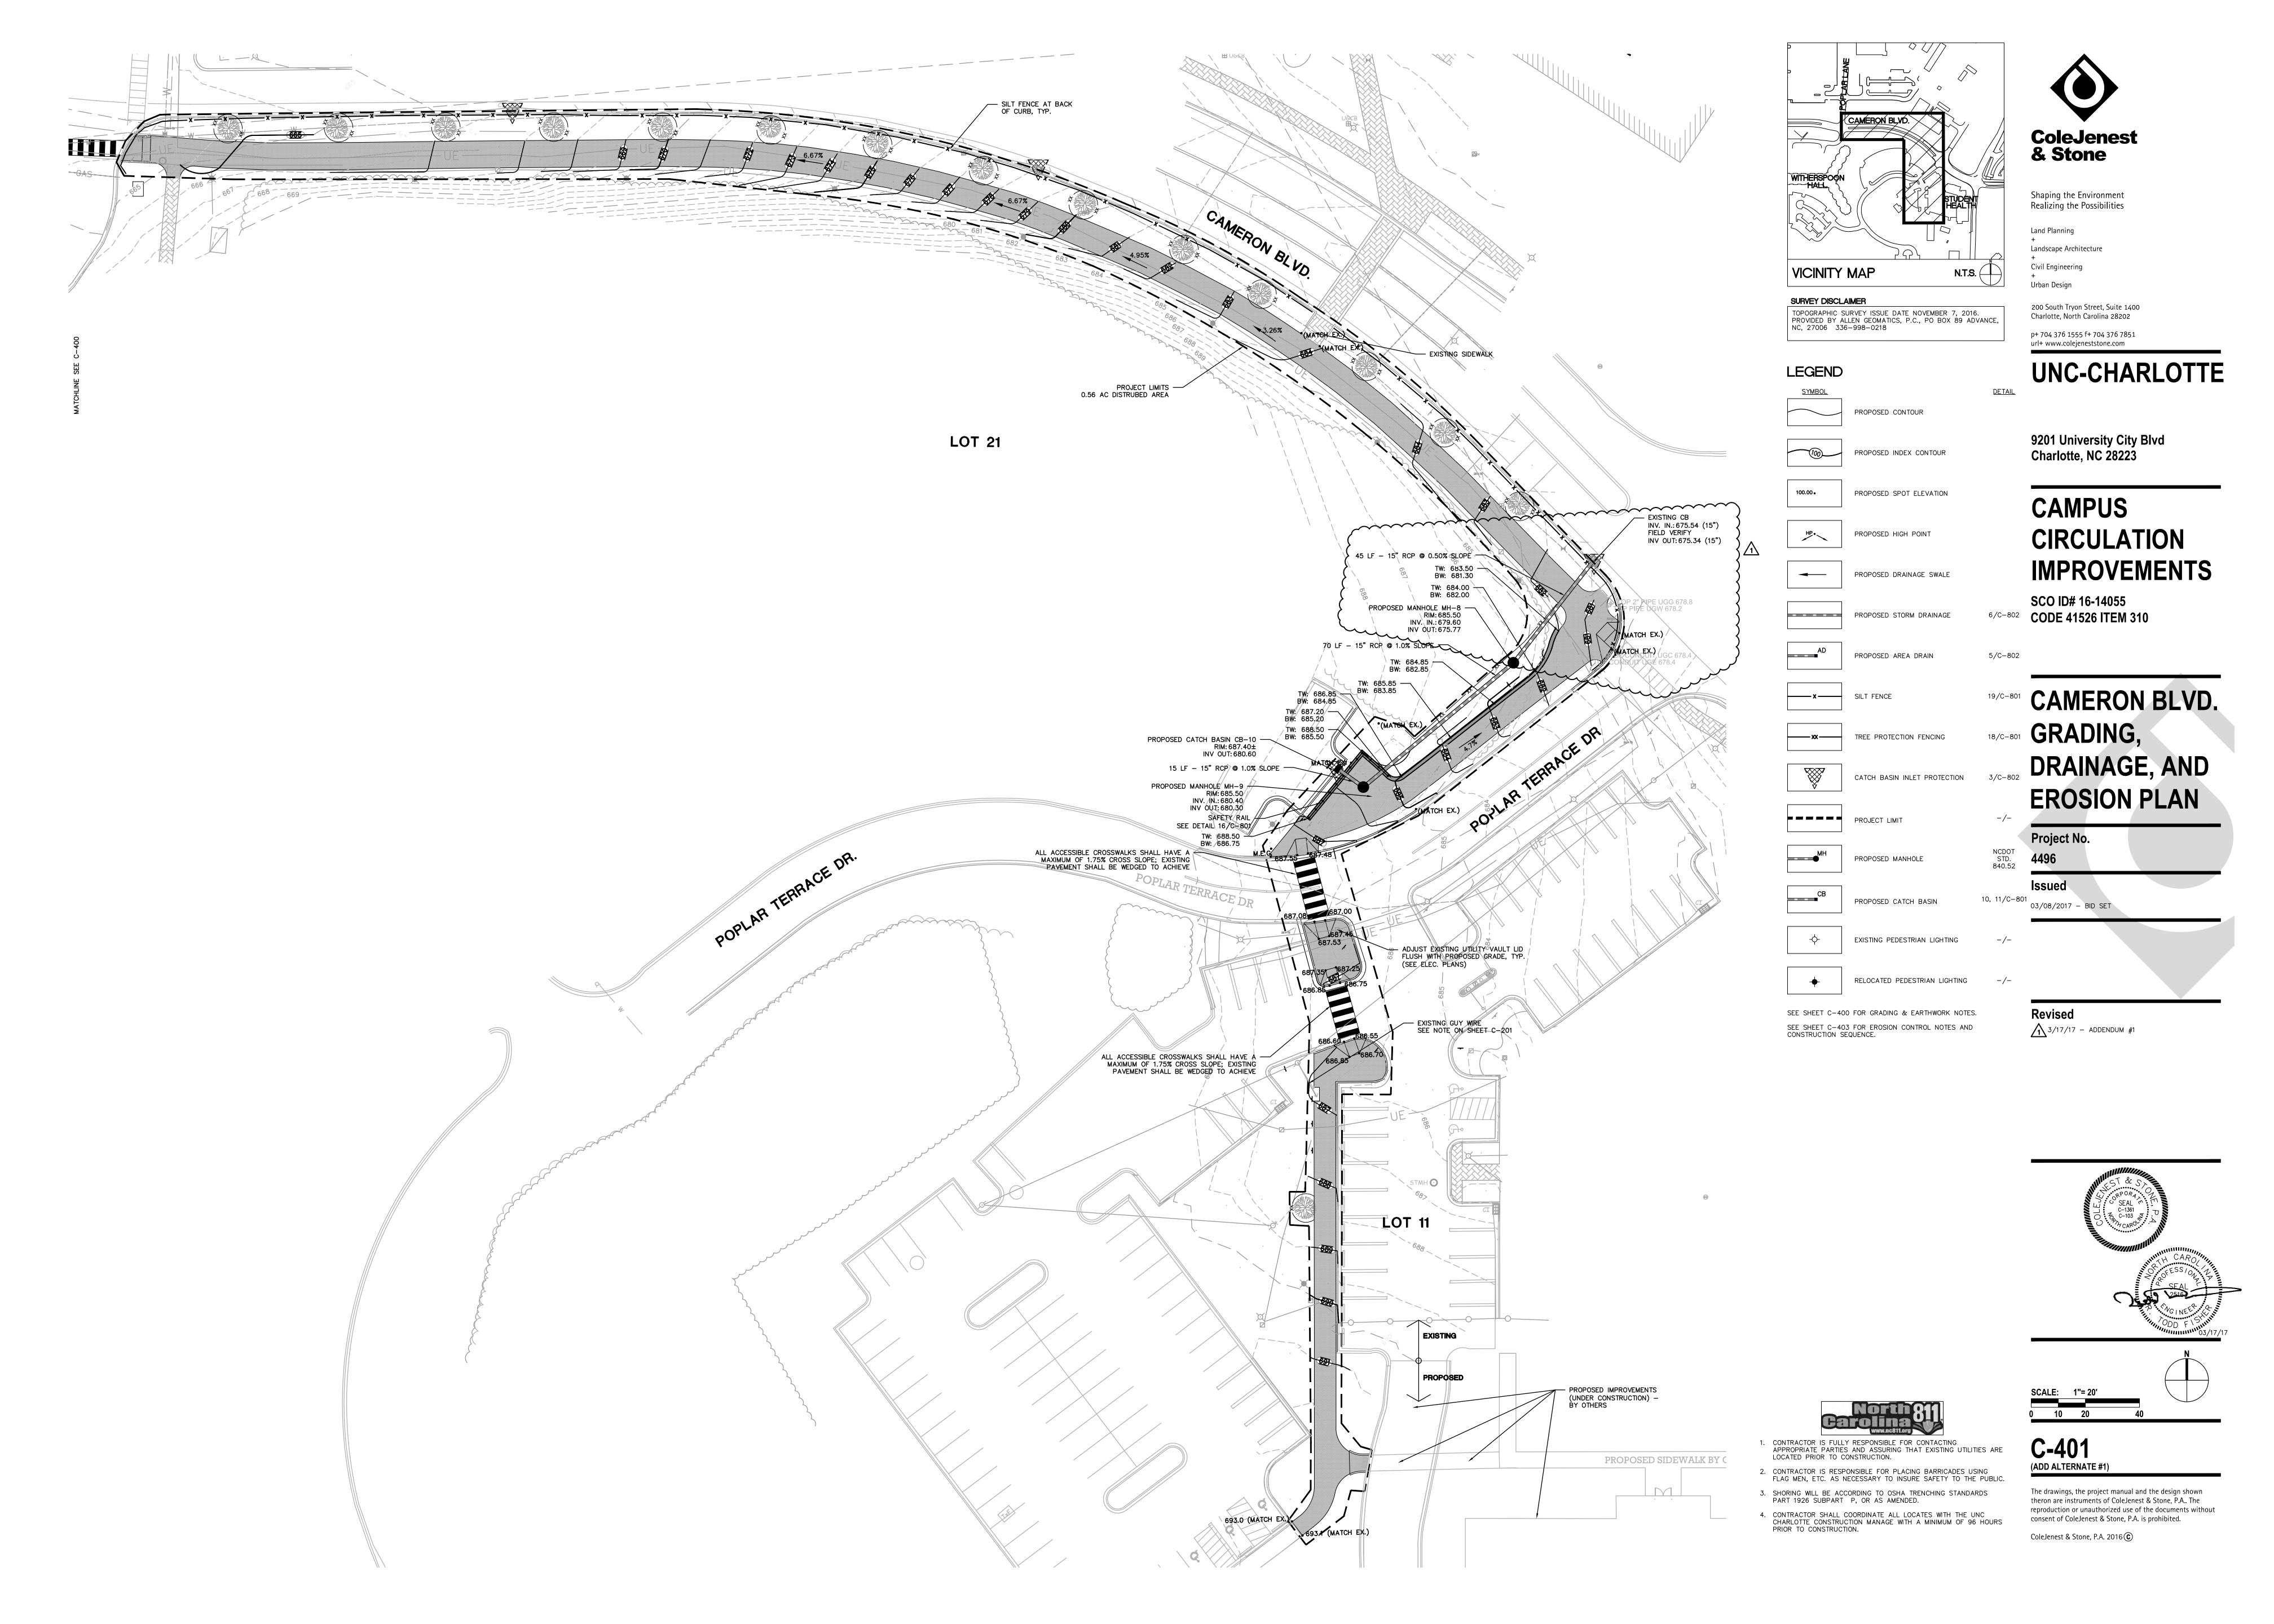

PLANT SCHEDULE BASE BID

QUANTITY	PROPOSED PLANT TYPE	PROPOSED PLANT SIZE	PLANT SPACING
5,259 SQ. FT.	SEED (SEE SPECIFICATIONS)	_	

PLANT SCHEDULE ALTERNATE #6A

QUANTITY	PROPOSED PLANT TYPE	PROPOSED PLANT SIZE	PLANT SPACING			
2	LIVE OAK	4" CAL	AS SHOWN			
2	CAMELLIA 'MAGNOLIAEFLORA'	36"-48" HT	AS SHOWN			
50	LEUCOTHOE 'RAINBOW'	18"-24" SPR.	AS SHOWN			
160	'WHITE PEARL' LENTEN ROSE	8"-12" HT.	AS SHOWN			
5,259 SQ. FT.	SOD (SEE SPECIFICATIONS)	_				

QUANTITY	PROPOSED PLANT TYPE	PROPOSED PLANT SIZE	PLANT SPACING
5	'WIRT L. WINN' HOLLY	7'-8' HT.	AS SHOWN
3	LIVE OAK	4" CAL.	AS SHOWN
2	CAMELLIA 'MAGNOLIAEFLORA'	36"-48" HT	AS SHOWN
50	LEUCOTHOE 'RAINBOW'	18"-24" SPR.	AS SHOWN
160	'WHITE PEARL' LENTEN ROSE	8"-12" HT.	AS SHOWN
364	LIRIOPE SPICATA	8"-12" HT.	AS SHOWN
9,857 SQ. FT.	SOD (SEE SPECIFICATIONS)	_	

PLANT SCHEDULE ALTERNATE #6B

PLANTING NOTES SIZE AND GRADING STANDARDS OF PLANT MATERIAL SHALL CONFORM TO THE LATEST EDITION OF "USA STANDARDS FOR NURSERY STOCK", BY THE AMERICAN ASSOCIATION

- OF NURSERYMAN, INC.
- 2. HEIGHT AND WIDTH SPECIFICATIONS INDICATED ON PLAN SHALL TAKE PRECEDENCE OVER CONTAINER SIZE AND CALIPER.
- 3. CONTRACTOR SHALL MULCH ALL SHRUB BEDS WITH 4" AGED SHREDDED HARDWOOD BARK, CONTRACTOR SHALL MULCH ALL ANNUAL/PERENNIAL BEDS WITH 1" PINE BARK
- 4. ALL DISTURBED AREAS NOT OTHERWISE PLANTED SHALL BE SEEDED BY THE CONTRACTOR (BASE BID) OR SODDED BY THE CONTRACTOR (BID ALT 6A/6B)
- 5. CONTRACTOR SHALL REMOVE ALL HARD LUMPS OF CLAY, STONES OVER 1" IN DIAMETER, AND ALL CONSTRUCTION DEBRIS INCLUDING GRAVEL, ROOTS, LIMBS AND OTHER DELETERIOUS MATTER WHICH WOULD BE HARMFUL, OR PREVENT PROPER ESTABLISHMENT AND/OR MAINTENANCE OF LAWN AND PLANTING AREAS.
- 6. IN AREAS WHERE CONSTRUCTION GRAVEL IS EMBEDDED IN THE SOIL, CONTRACTOR SHALL REMOVE CONTAMINATED SOIL TO A DEPTH OF 18" AND FILL WITH CLEAN TOPSOIL. CONTRACTOR SHALL IMPORT TOPSOIL AT NO CHARGE TO OWNER IF REQUIRED TO FILL THESE EXCAVATIONS.
- 7. CONTRACTOR SHALL RESOD LAWN AREAS DAMAGED DUE TO PLANT MATERIAL INSTALLATION. 8. ALL STRAPPING AND TOP 2/3 OF WIRE BASKET SHALL BE CUT AWAY AND REMOVED
- BY THE CONTRACTOR FROM ROOT BALL PRIOR TO BACKFILLING PLANTING PIT. CONTRACTOR SHALL REMOVE TOP 1/3 OF THE BURLAP FROM ROOT BALL. BA. FOR NEW TREE PLANTING AREAS, CONTRACTOR SHALL REMOVE ALL PAVEMENT, SGRAVEL SUB-BASE AND CONSTRUCTION DEBRIS; REMOVE COMPACTED SOIL AND ADD
- 24" NEW TOPSOIL, OR AMEND THE TOP 24" OF EXISTING SOIL, TO MEET SPECIFIED TOPSOIL/PLANTING MIX STANDARDS FOR TREES. INCLUDE IN BASE BID LARGE MATURING TREES SHALL BE A MINIMUM 25 TO 30 FEET FROM OVERHEAD

DISTRIBUTION OR TRANSMISSION LINES. IF TREES CONFLICT WITH POWER LINES OR

SIGNS, CONTRACTOR SHALL CONTACT LANDSCAPE ARCHITECT TO RESOLVE BEFORE

- MINIMUM TREE SIZE AT PLANTING SHALL BE 3 INCH CALIPER FOR LARGE MATURING TREES AND 2 INCH CALIPER FOR SMALL MATURING TREES. ALL MULTI-STEM PLANTS SHALL BE TREE FORM, MAXIMUM THREE TO FIVE TRUNKS, AND A MINIMUM EIGHT FEET
- INSTALLER SHALL BE RESPONSIBLE TO REPAIR OR REPLACE PLANTINGS THAT FAIL IN MATERIALS, WORKMANSHIP, OR GROWTH WITHIN SPECIFIED WARRANTY PERIOD (ONE YEAR FROM DATE OF FINAL ACCEPTANCE BY OWNER).
- 12. FOR SEEDED AREAS, AN ACCEPTABLE LAWN AT THE END OF THE MAINTENANCE PERIOD SHALL CONSIST OF A HEALTHY, UNIFORM, CLOSE STAND OF GRASS, FREE OF WEEDS AND SURFACE IRREGULARITIES, WITH TOTAL GRASS COVERAGE EXCEEDING 90 PERCENT OVER ANY 10 SQ. FT. AND BARE SPOTS NOT EXCEEDING 5 BY 5 INCHES, WITH AT LEAST 85% OF THE TOTAL GRASS COVERAGE CONSISTING OF THE SPECIFIED
- ANY AND ALL DAMAGE TO EXISTING IRRIGATION SYSTEM IS THE CONTRACTOR'S RESPONSIBILITY TO REPAIR. CONTRACTOR TO COORDINATE WITH CONSTRUCTION MANAGER TO ENSURE IRRIGATION TEAM INSPECTS THE REPAIR WORK BEFORE IT IS

TREE PROTECTION NOTES

- TREE PROTECTION FENCING MUST BE INSTALLED BEFORE ANY DEMOLITION, CLEARING OR GRADING BEGINS, AND NOT REMOVED UNTIL FINAL INSPECTION. THE TREE PROTECTION FENCE SHALL BE LOCATED ALONG THE PERIMETER OF THE TREE SAVE AREA (DRIP LINE PLUS 5 FEET). TREE PROTECTION FENCING FOR A FOREST CANOPY STAND AREA IS TO BE LOCATED ALONG THE PERIMETER OF THE TREE SAVE AREA AROUND THE FOREST EDGE. TREE PROTECTION FENCING SHALL CONSIST OF ORANGE SAFETY FENCING OR A COMBINATION OF ORANGE SAFETY FENCING WITH SILT FENCING AT A MINIMUM OF 4 FEET IN HEIGHT ON METAL OR WOOD POSTS.
- CONSTRUCTION MATERIAL, VEHICULAR TRAFFIC, OR STORAGE OF EQUIPMENT AND MATERIALS ARE ALLOWED WITHIN THE TREE SAVE AREA. NO ROPES, SIGNS, WIRES, UNPROTECTED ELECTRICAL INSTALLATION OR OTHER DEVICE OR MATERIAL, SHALL BE SECURED OR FASTENED AROUND OR THROUGH A TREE OR

NO SOIL DISTURBANCE OR COMPACTION, STOCK PILING OF SOIL OR OTHER

ALL PROTECTIVE MEASURES SHALL BE MAINTAINED THROUGHOUT THE LAND DISTURBING AND CONSTRUCTION PROCESS, AND SHALL NOT BE REMOVED UNTIL FINAL

CAMERON BLVD

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EXISTING TREELINE

PROPOSED TREELINE

PROPOSED TREE

PROPOSED SHRUBS

PROPOSED SOD

PROPOSED GROUNDCOVER

PROPOSED LIGHT FIXTURE SEE ELECTRICAL PLAN

VICINITY MAP

NC, 27006 336-998-0218

p+ 704 376 1555 f+ 704 376 7851 url+ www.colejeneststone.com **UNC-CHARLOTTE**

DETAIL

N.T.S.

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ColeJenest

& Stone

Shaping the Environment

Realizing the Possibilities

200 South Tryon Street, Suite 1400

Charlotte, North Carolina 28202

Land Planning

Civil Engineering

Urban Design

Landscape Architecture

CAMPUS 17/C-801 CIRCULATION


IMPROVEMENTS

SCO ID# 16-14055 CODE 41526 ITEM 310

MAIN STATION -PLANTING PLAN (WALLIS HALL)

03/17/17 - ADDENDUM #1



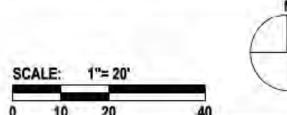


(BASE BID/ALT, #6A/6B)


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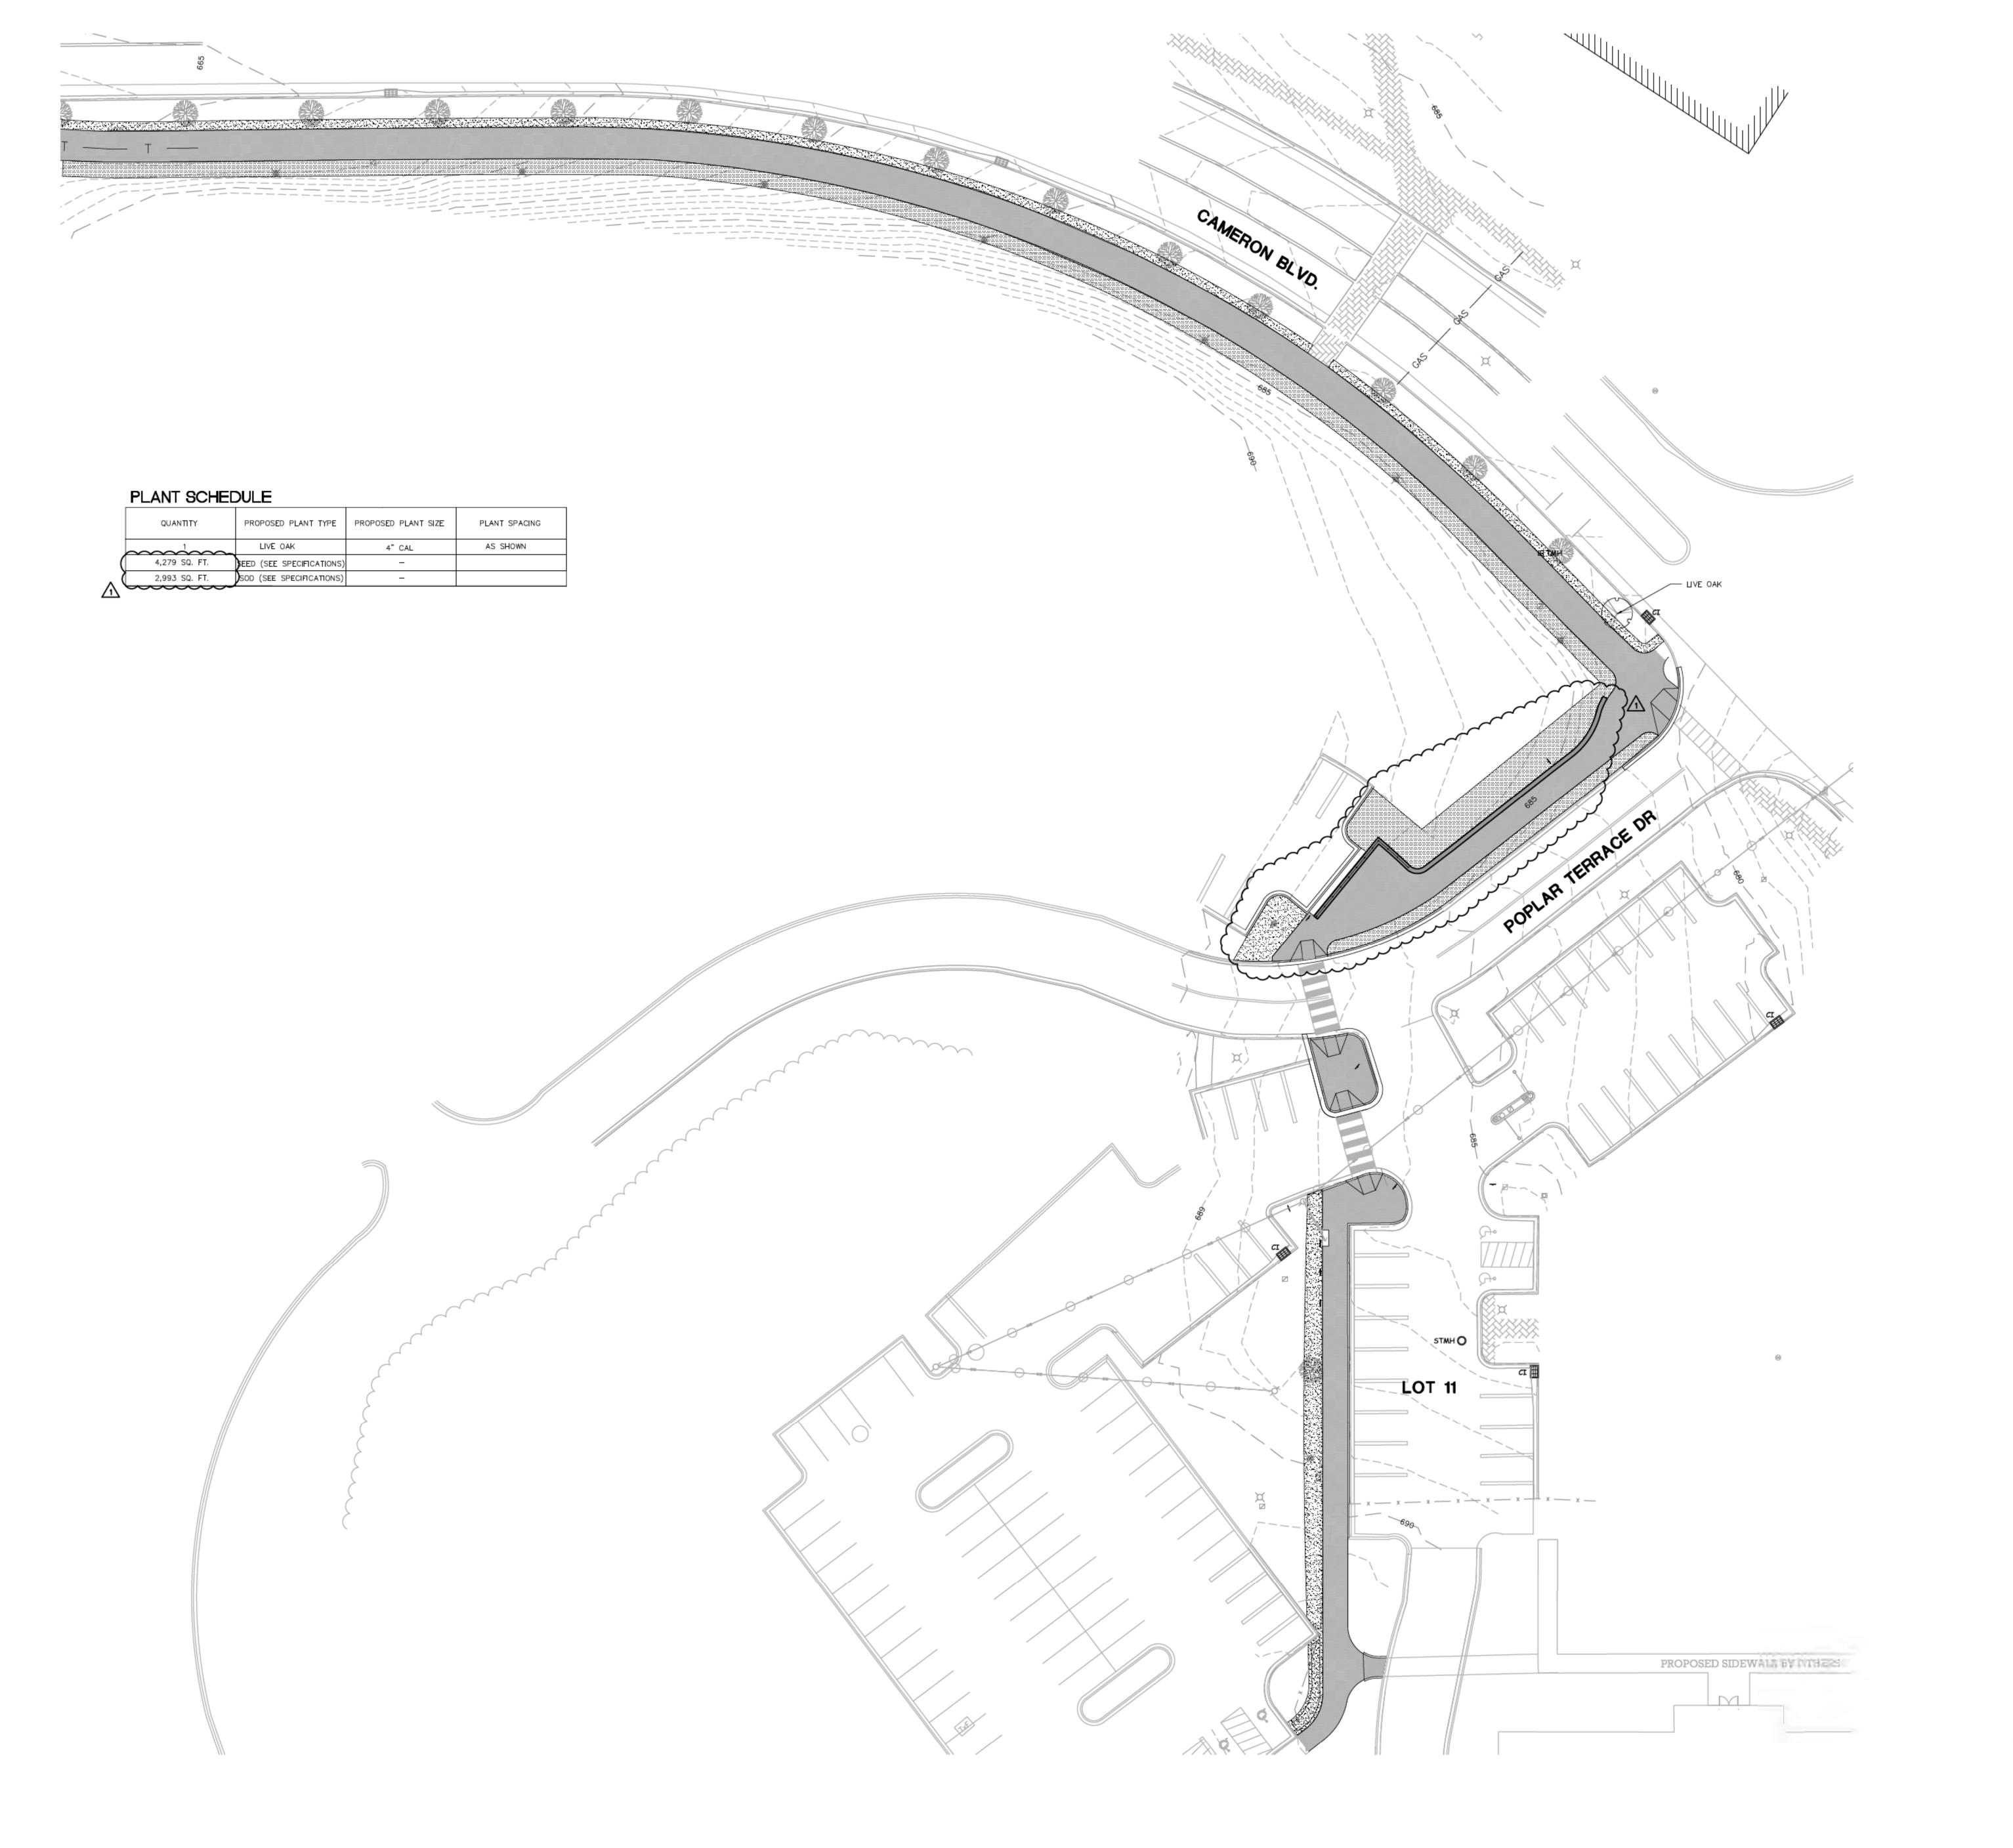
SCALE: 1' = 20' Morth 91


- CONTRACTOR IS FULLY RESPONSIBLE FOR CONTACTING APPROPRIATE PARTIES AND ASSURING THAT EXISTING UTILITIES ARE LOCATED PRIOR TO CONSTRUCTION.
- CONTRACTOR IS RESPONSIBLE FOR PLACING BARRICADES USING FLAG MEN, ETC. AS NECESSARY TO INSURE SAFETY TO THE PUBLIC.
- 3. SHORING WILL BE ACCORDING TO OSHA TRENCHING STANDARDS PART 1926 SUBPART P, OR AS AMENDED.
- CONTRACTOR SHALL COORDINATE ALL LOCATES WITH THE UNC CHARLOTTE CONSTRUCTION MANAGE WITH A MINIMUM OF 96 HOURS PRIOR TO CONSTRUCTION.



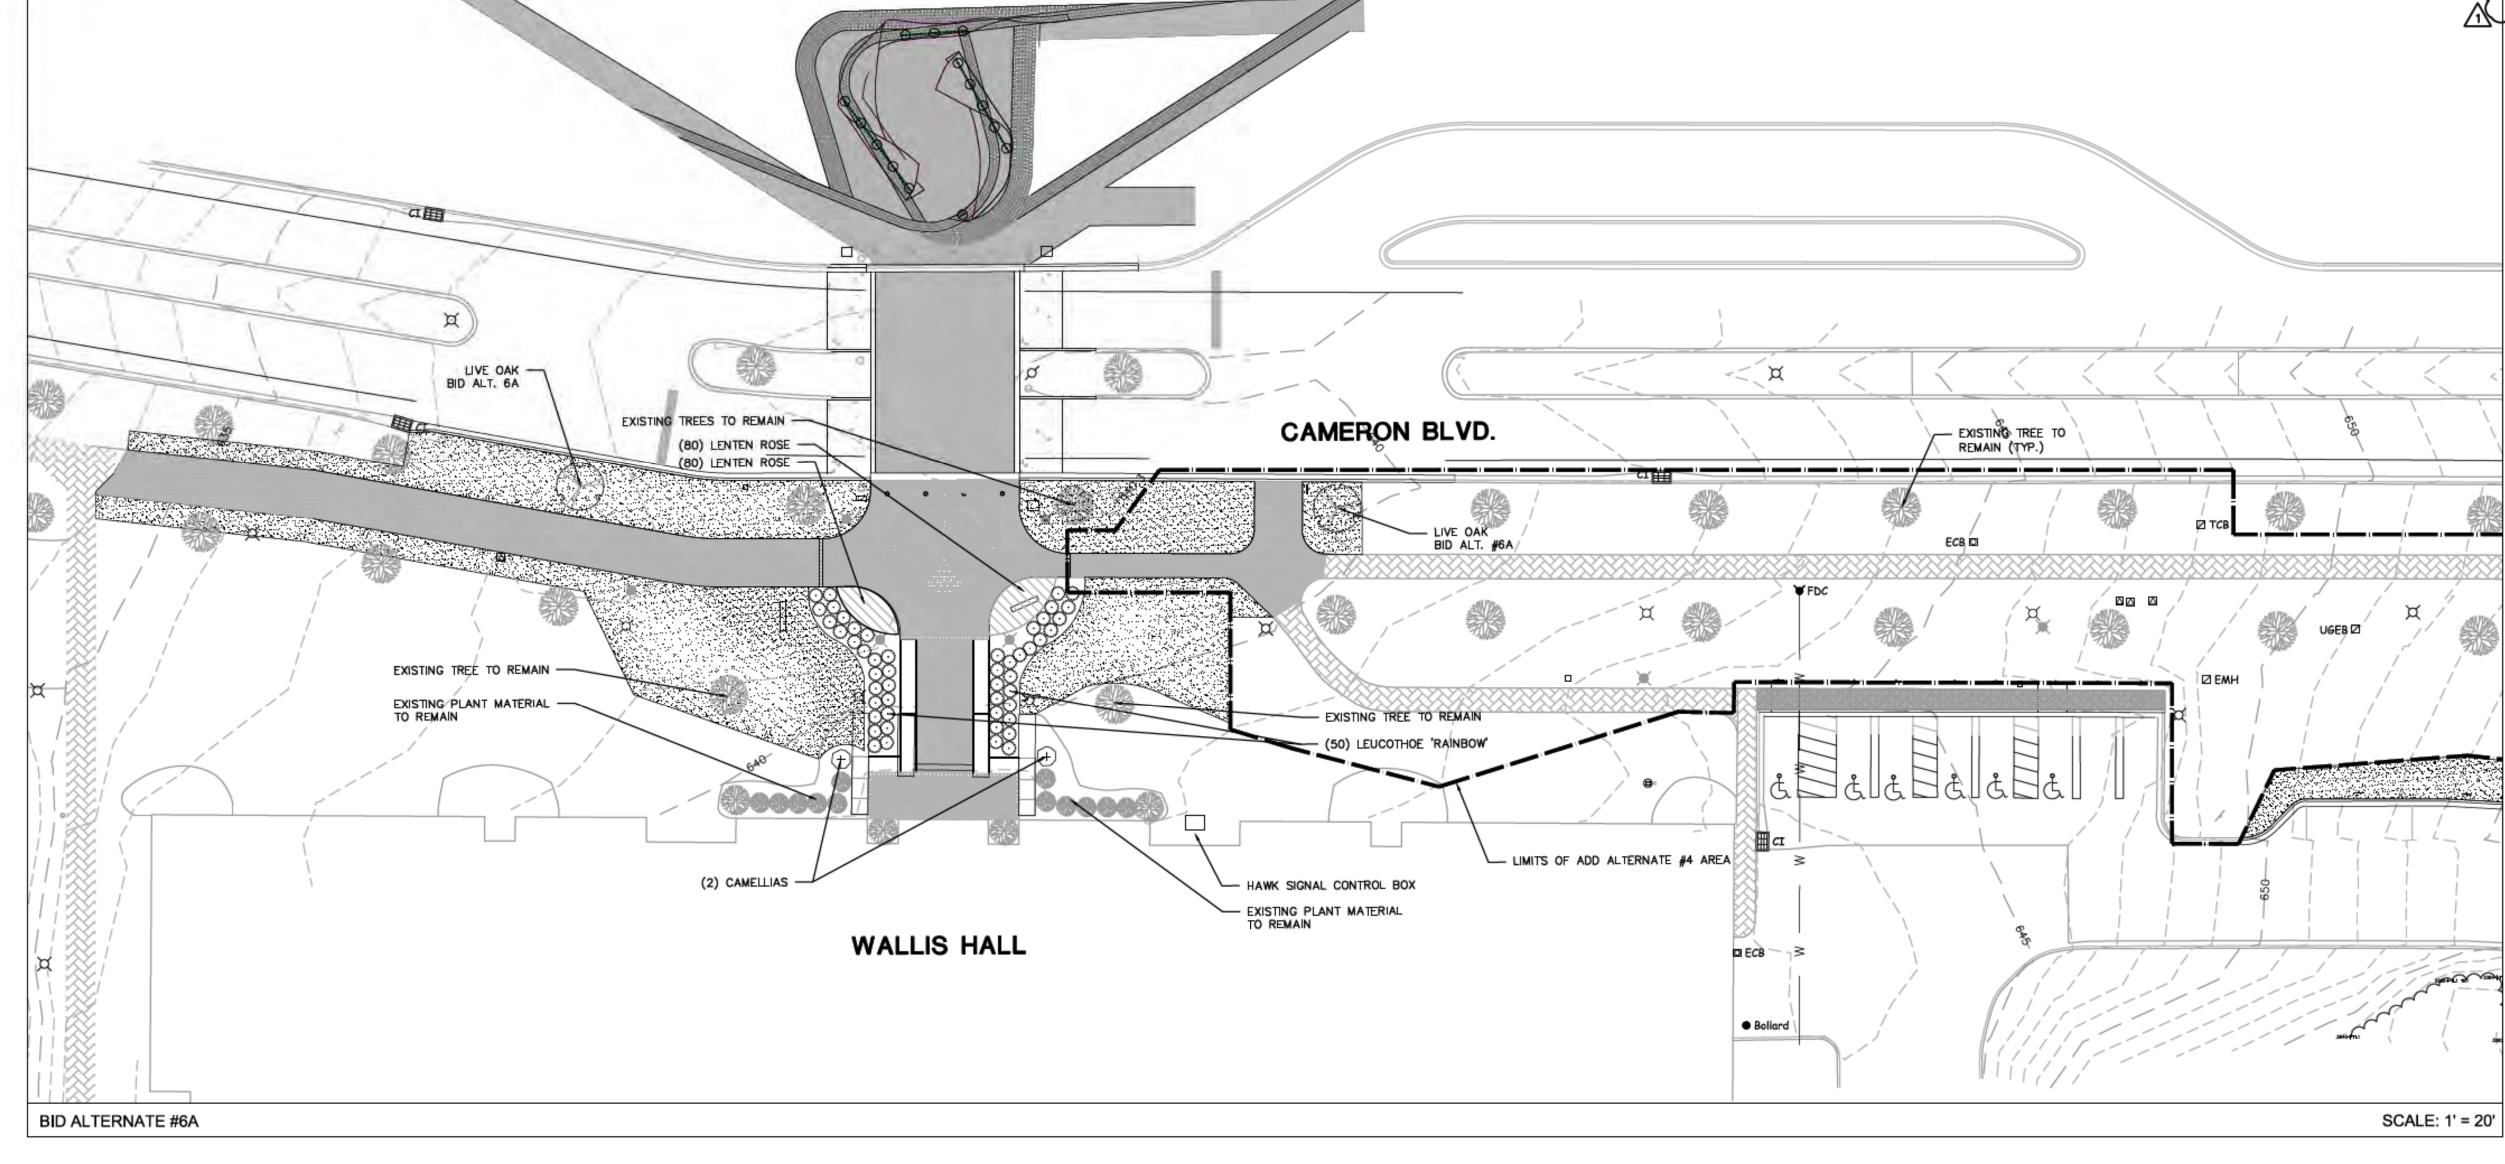

BASE BID: INCLUDES PLANTING BED AND SOIL PREPARATION/TOPSOIL INSTALLATION PER SPECIFICATION 329000 AND 329300, WITH SEED AND MULCH ONLY. ALL PLANT MATERIAL OTHER THAN SEED AND MULCH IS BID AS ALTERNATE.

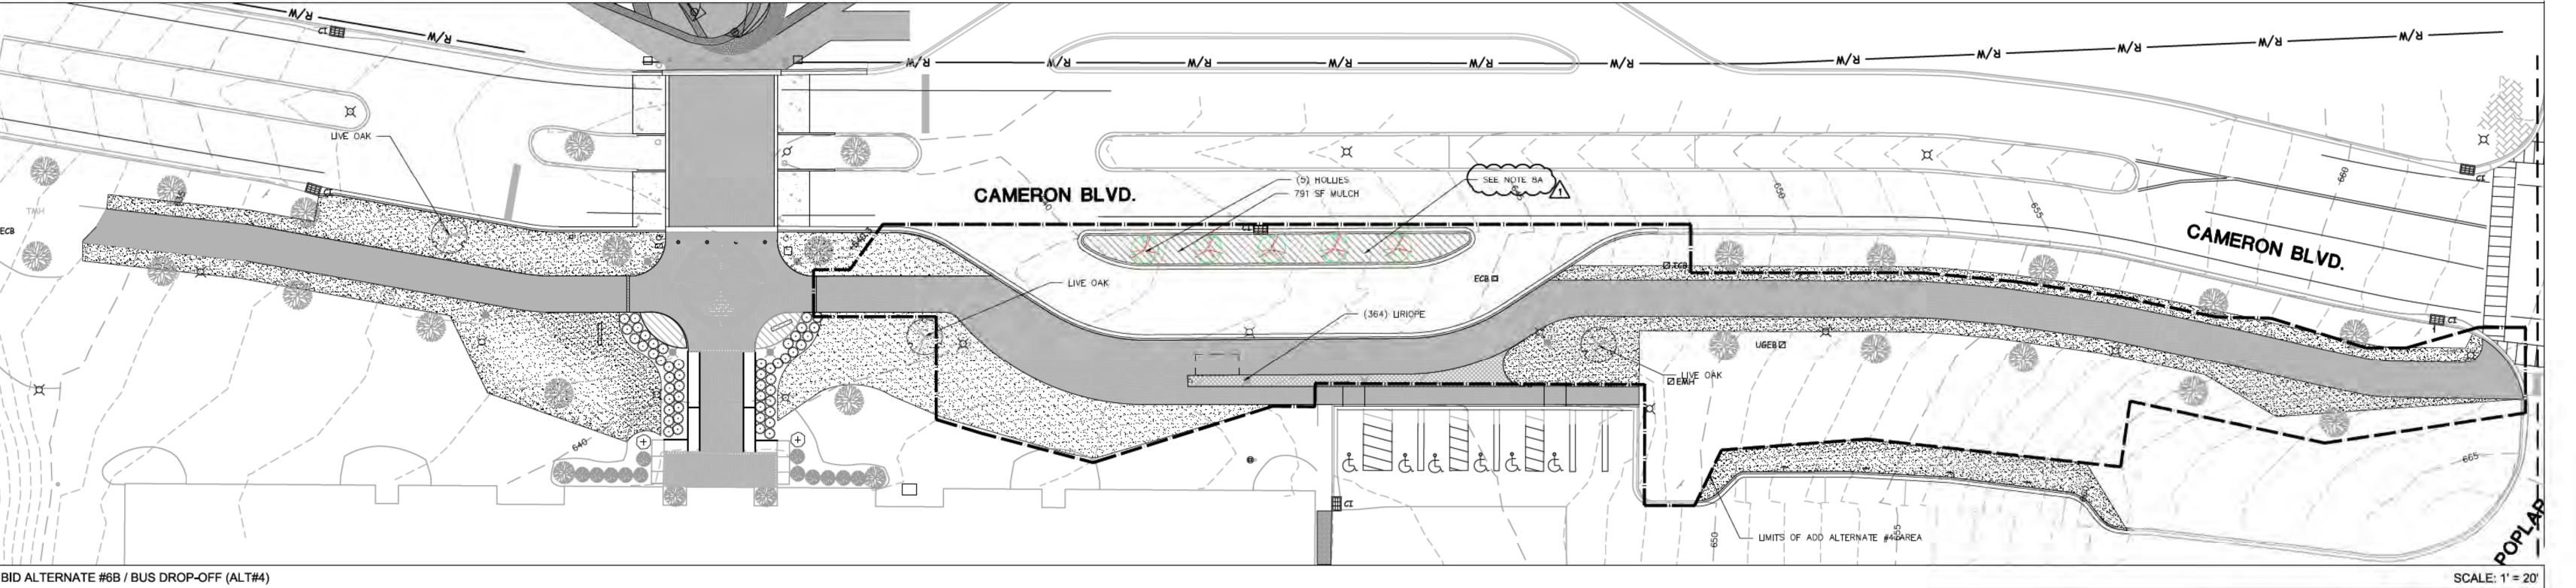

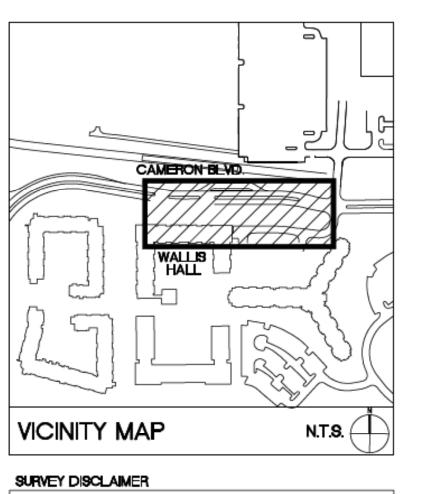

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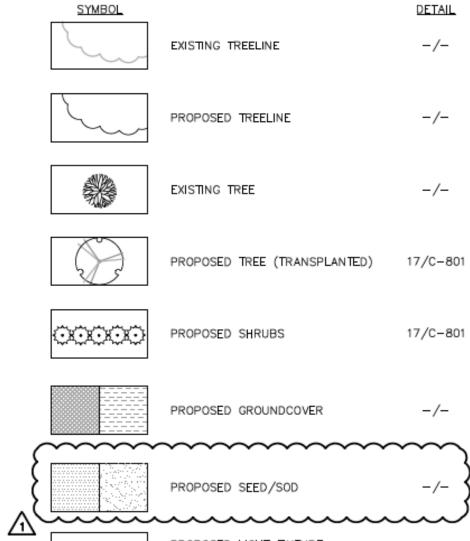
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LEGEND



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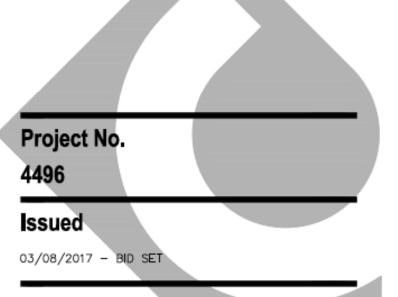
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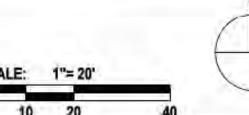


Revised

03/17/17 - ADDENDUM #1




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- SHORING WILL BE ACCORDING TO OSHA TRENCHING STANDARDS PART 1926 SUBPART P, OR AS AMENDED.
- CONTRACTOR SHALL COORDINATE ALL LOCATES WITH THE UNC CHARLOTTE CONSTRUCTION MANAGE WITH A MINIMUM OF 96 HOURS PRIOR TO CONSTRUCTION.





C-701 (ADD ALTERNATE #1)

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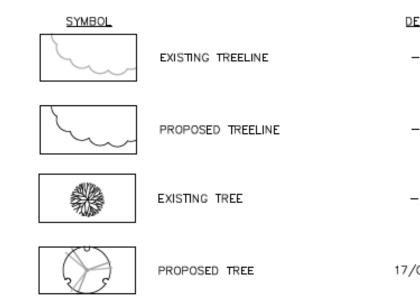
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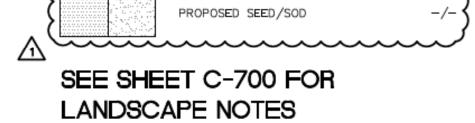
PROPOSED SHRUBS

LEGEND
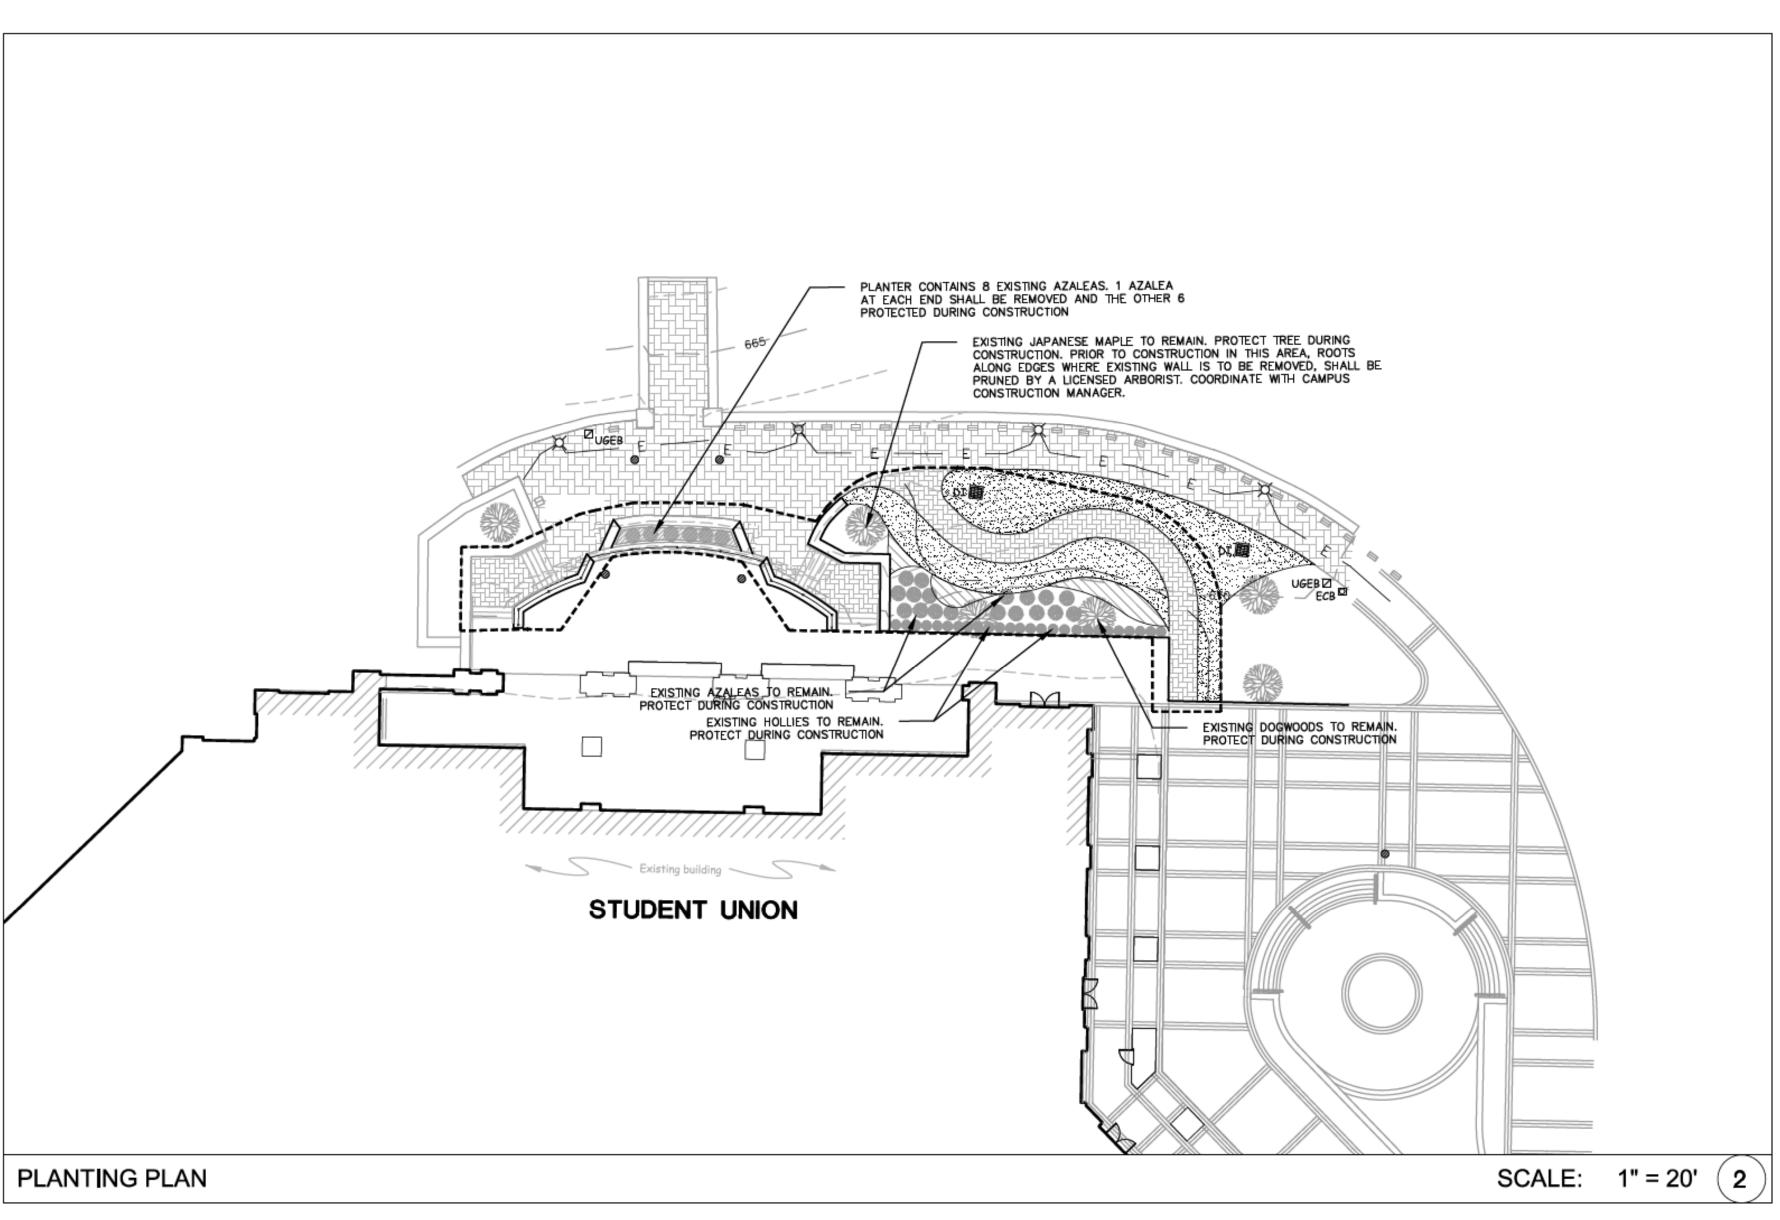
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CAMPUS 17/C-801 CIRCULATION **IMPROVEMENTS**

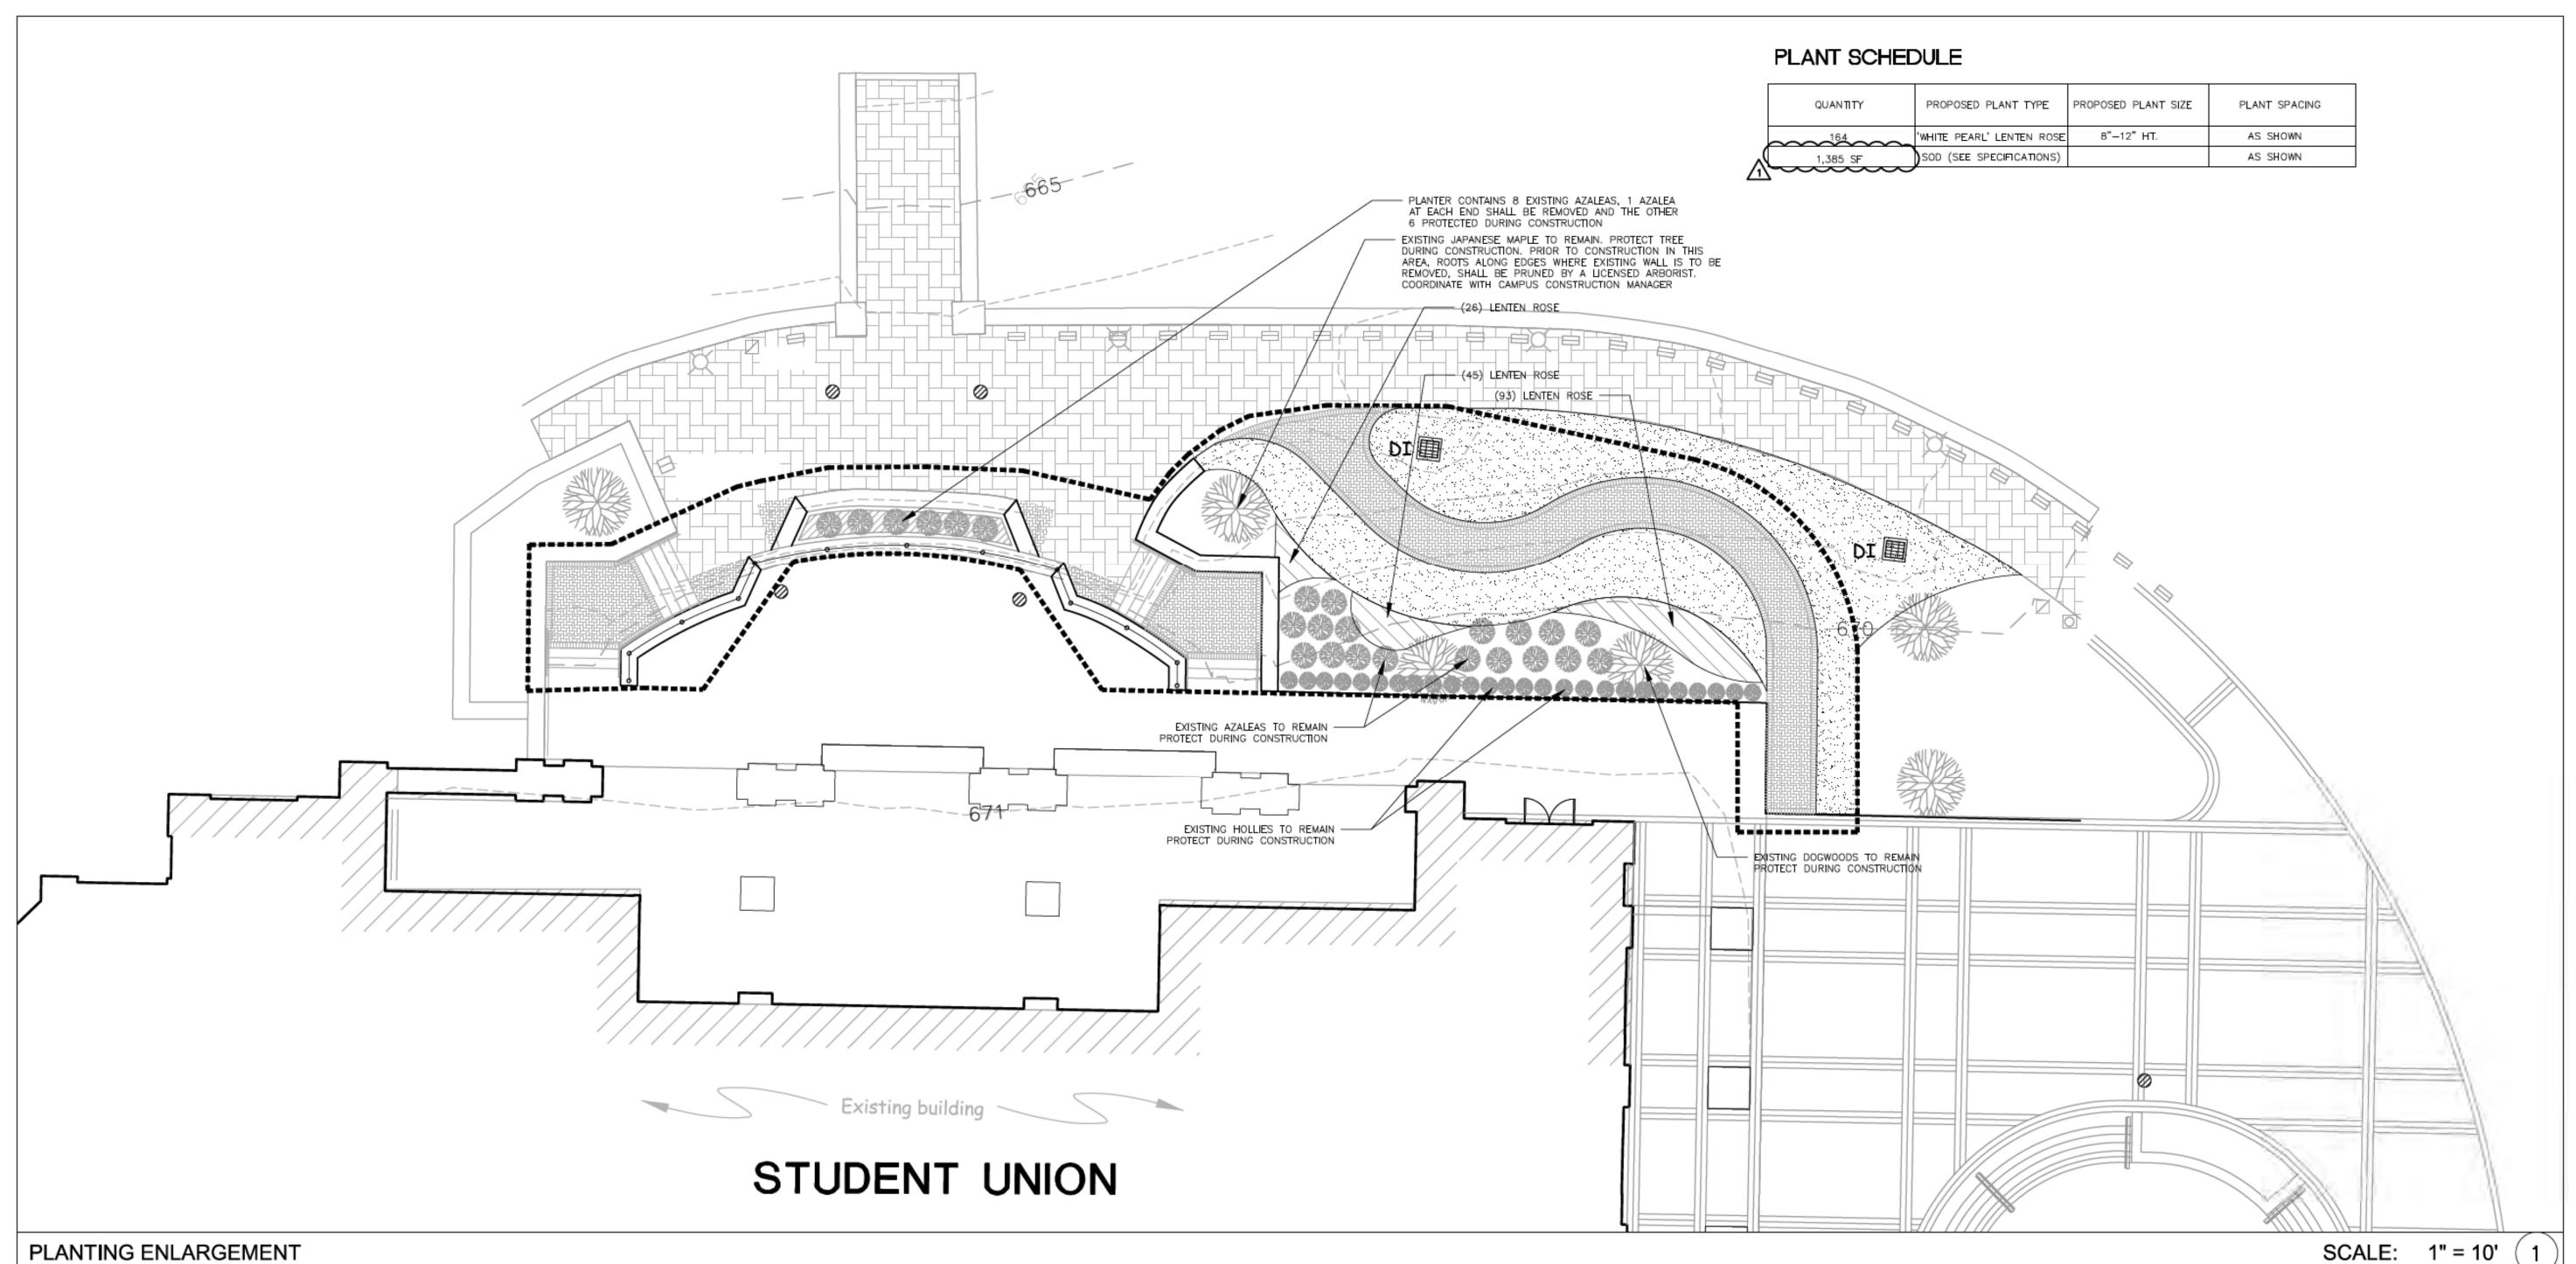SCO ID# 16-14055 CODE 41526 ITEM 310 PROPOSED GROUNDCOVER

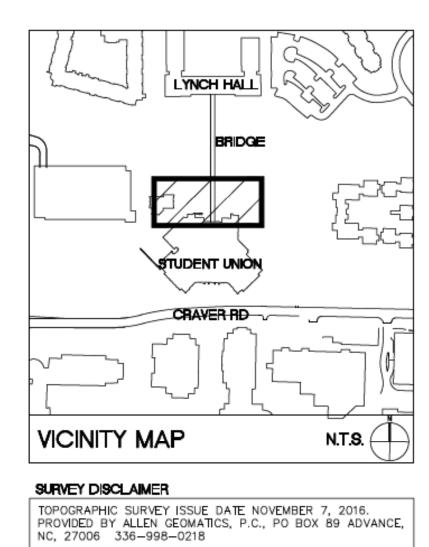

STUDENT UNION -PLANTING PLAN




Revised 1 03/17/17 - ADDENDUM #1




Morth?


- 1. CONTRACTOR IS FULLY RESPONSIBLE FOR CONTACTING APPROPRIATE PARTIES AND ASSURING THAT EXISTING UTILITIES ARE LOCATED PRIOR TO CONSTRUCTION.
- CONTRACTOR IS RESPONSIBLE FOR PLACING BARRICADES USING FLAG MEN, ETC. AS NECESSARY TO INSURE SAFETY TO THE PUBLIC.
- SHORING WILL BE ACCORDING TO OSHA TRENCHING STANDARDS PART 1926 SUBPART P, OR AS AMENDED.
- CONTRACTOR SHALL COORDINATE ALL LOCATES WITH THE UNC CHARLOTTE CONSTRUCTION MANAGE WITH A MINIMUM OF 96 HOURS PRIOR TO CONSTRUCTION.

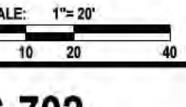

C-702 (ADD ALTERNATE #2)

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GENERAL NOTES:

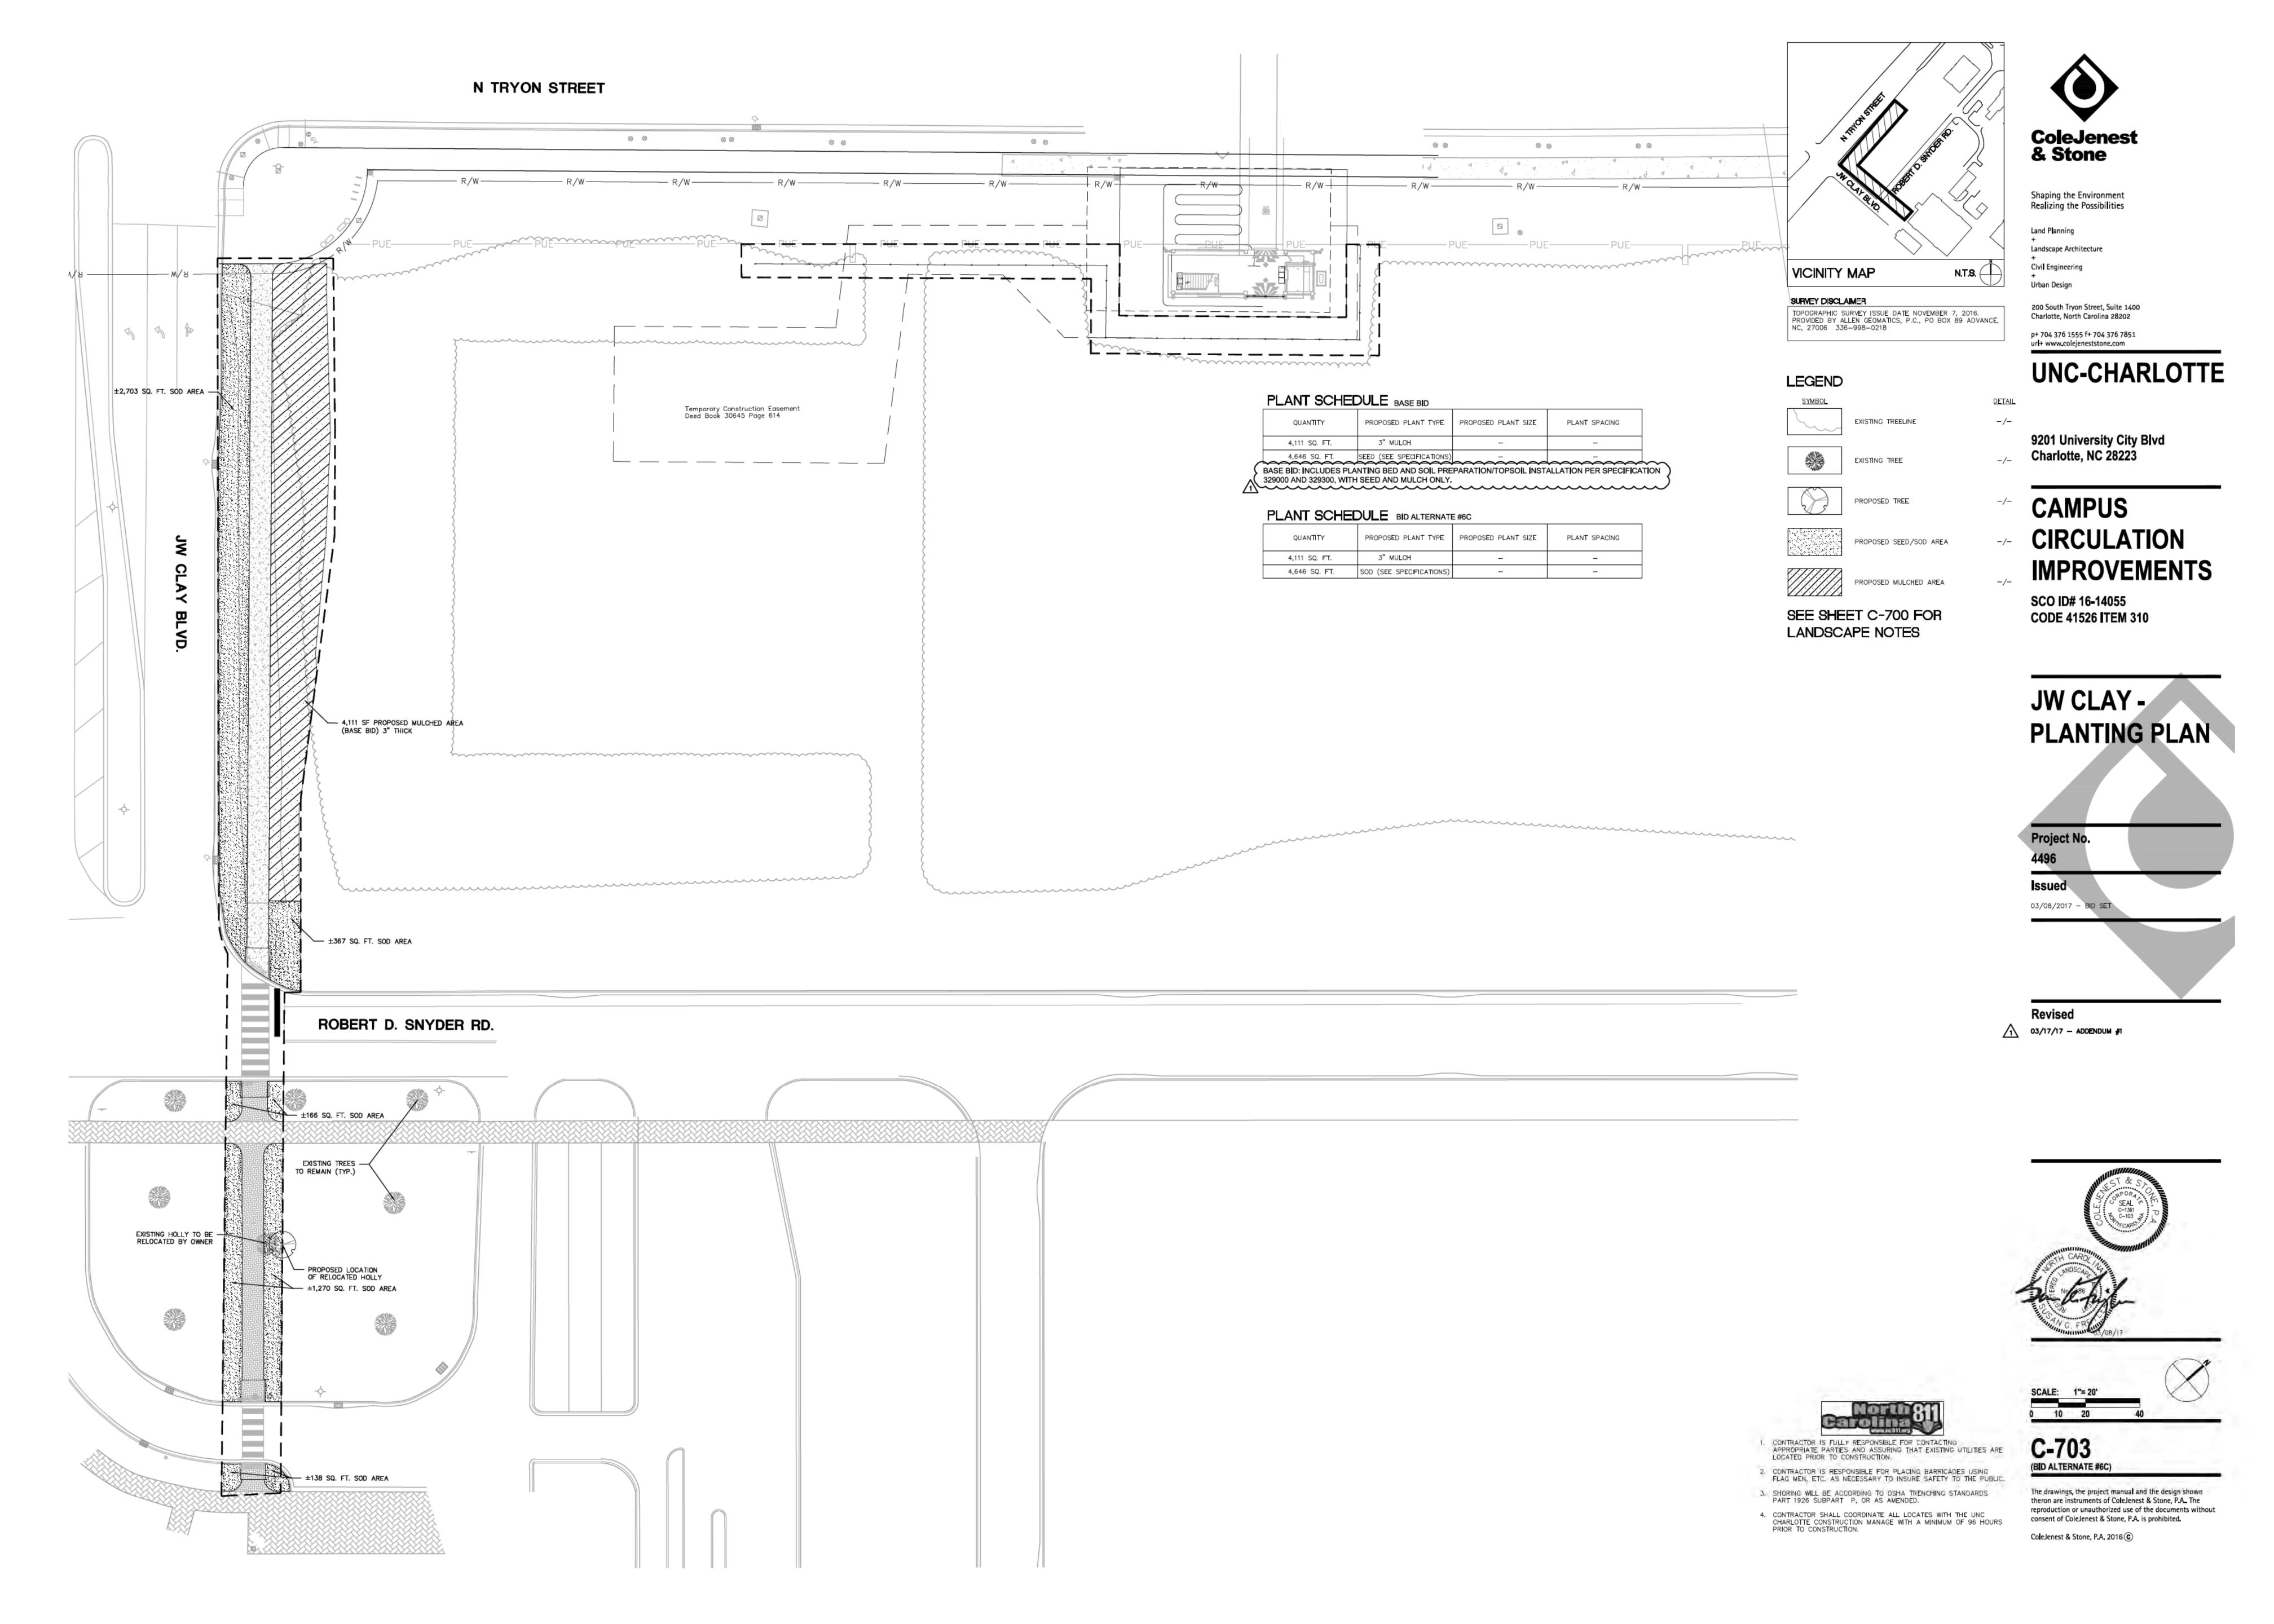- 1. ALL ELECTRICAL LINES SERVING NEW PEDESTRIAN AND TRAFFIC CONTROLS SHALL BE LOCATED UNDERGROUND.
- 2. PROVIDE TRAFFIC RATED HAND HOLES AS NECESSARY FOR ROUTING CONDUITS UNDER GROUND AND RECONNECT EXISTING SITE LIGHTING.
- 3. SEE PLANTING PLAN FOR TREE LOCATIONS
- 4. REFER TO CIVIL PLANS FOR EXISTING POLES TO REMAIN, BE RELOCATED, OR TO BE REMOVED. PROVIDE NEW WIRING (2#10, 1#10, 1"C) TO EXTEND EXISTING CIRCUITS TO NEW LIGHT POLE LOCATIONS.
- 5. PROVIDE STAINLESS STEEL LOCKABLE GASKETED ENCLOSURE TO PROTECT EQUIPMENT & CONTROLS FOR EACH TRAFFIC CONTROL CABINET.
- 6. COORDINATE AND CONFIRM FINAL LOCATION OF LIGHTS WITH UNCC CONSTRUCTION MANAGER IN THE EVENT A PROPOSED LIGHT POLE LOCATION IS IN CONFLICT WITH AN EXISTING OR PROPOSED UTILITY.

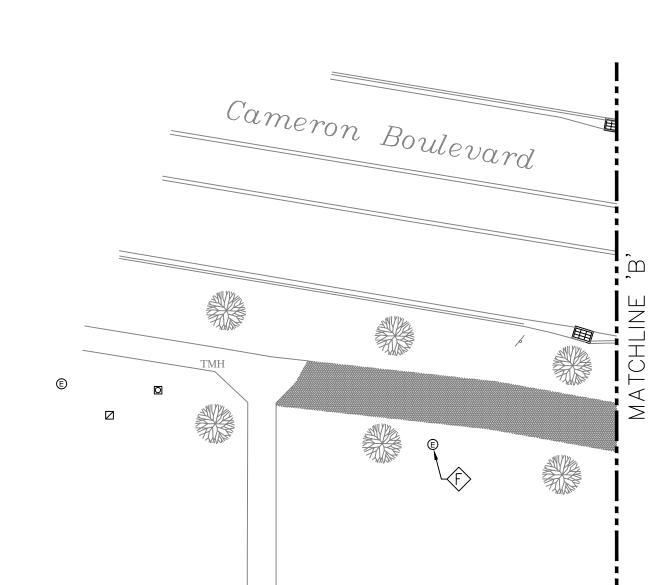HAVE EXISTING UTILITIES LOCATED. REPORT ANY DISCREPANCIES TO THE ENGINEER.

- 7. CONTRACTOR SHALL BE FULLY RESPONSIBLE TO CALL NORTH CAROLINA ONE—CALL CENTER (1-800-632-4949)
 AND UNIVERSITY OF NORTH CAROLINA AT CHARLOTTE AT LEAST 48 HOURS PRIOR TO UNDERGROUND WORK TO
- 8. CONTRACTOR SHALL BE FULLY RESPONSIBLE TO CONTRACT WITH PRIVATE UTILITY LOCATOR TO HAVE ALL EXISTING UTILITIES LOCATED.
- 9. ALL EXISTING UTILITIES ARE SHOWN AT APPROXIMATE LOCATIONS. CONTRACTOR IS FULLY RESPONSIBLE TO FIELD VERIFY ACTUAL LOCATION AND DEPTH OF EXISTING UTILITIES PRIOR TO THE START OF CONSTRUCTION.
- 10. THE CONTRACTOR SHALL ENSURE THAT ALL OCCUPATIONAL SAFETY AND HEALTH ADMINISTRATION (OSHA)
 REGULATIONS AND STANDARDS ARE FOLLOWED DURING ALL PHASES OF THE CONSTRUCTION PROJECT. SHEETING OR
 BRACING SHALL BE USED WHENEVER NECESSARY TO PREVENT FAILURE OF THE TRENCH BANKS. ALL SHEETING
 SHALL CONFORM TO AASHTO AND OSHA SAFETY STANDARDS.
- 11. THE CONTRACTOR SHALL BE FULLY RESPONSIBLE TO PROVIDE SIGNS, BARRICADES, WARNING LIGHTS, GUARD RAILS, AND EMPLOY FLAGGERS AS NECESSARY WHEN CONSTRUCTION ENDANGERS EITHER VEHICULAR OR PEDESTRIAN TRAFFIC. THESE DEVICES SHALL REMAIN IN PLACE UNTIL THE TRAFFIC MAY PROCEED NORMALLY AGAIN.
- 12. CONSTRUCTION WORK ZONE SIGNS AND SIGNING PROCEDURES SHALL CONFORM TO THE MUTCD AND SUPPLEMENTS AND TO ALL APPLICABLE FEDERAL, STATE, AND LOCAL CODES.
- 13. SEE SHEET C-900 FOR LOCATION OF PEDESTRIAN SIGNAL POLES.
- 14. ADJUST ALL EXISTING ELECTRICAL HAND HOLES VERTICALLY AND HORIZONTALLY AS REQUIRED TO AVOID NEW CONDITIONS, FLUSH WITH SURROUNDING SURFACES AND COORDINATE WITH CIVIL DRAWINGS AND OWNER FINAL LOCATIONS.

KEY NOTES

- NEW 12" X 12" HAND HOLE FOR SITE LIGHTING CIRCUITS PROVIDE NEW 2#10, 1#10G, 1"C TO RECONNECT EXISTING CIRCUIT.
- B LOCATION FOR RELOCATED EXISTING SITE LIGHTING POLE. SEE DETAIL FOR PAVER MOUNTING. PROVIDE NEW POLE BASE. EXTEND CONDUIT AND RECONNECT TO EXISTING SITE LIGHTING CIRCUIT WITH 2#12, 1#12G, 1"C.
- LIGHTING POLES. SEE SHEET C-900 & C-901, SEE DETAIL 12/E-102, COORDINATE FINAL STYLE, HEIGHT, FINISH, LOCATION, ETC. WITH C.M.

 D> PROVIDE CONDUIT SLEEVES TO ENCLOSE EXISTING EXPOSED WIRING INTO

NEW SIGNAL LIGHT AND POLE, DECORATIVE TO MATCH PEDESTRIAN

- ENCLOSURES


 F) PROVIDE NEW 24"Y24"Y18" D HAND HOLE FOR POWER DISTRIBUTION
- E> PROVIDE NEW 24"X24"X18" D HAND HOLE FOR POWER DISTRIBUTION

 F> PROVIDE UL LISTED LED RETROFIT KIT FROM ORIGINAL EQUIPMENT
- MANUFACTURER

 G EXISTING SITE STREET LIGHT TO REMAIN.

CONTROL SYSTEM.

- PROVIDE (4) 20A-120V NEMA 5-20R GFCI RECEPTACLES FOR TRAFFIC
- PROVIDE NEW STAINLESS STEEL PANELBOARD ENCLOSURE, ON 60"x36" CONCRETE PAD, SEE DETAIL.
- EXISTING BLUE LIGHT TO REMAIN UNDER BASE BID. REMOVE EXISTING BLUE LIGHT PHONE, ASSOCIATED CONDUIT, WIRE AND HAND HOLES UNDER ALTERNATE #4.
- LOCATION FOR NEW BLUE LIGHT PHONE AND ASSOCIATED EQUIPMENT. PROVIDE NEW 2#10, 1#10G IN 1"C TO NEW LOCATION. COORDINATE WITH UNCC I.T. STAFF FOR NEW TELECOM CABLE. PROVIDE 1½"C TO WALLIS BLDG I.T. ROOM. PROVIDE ONE 12" X 12" HAND HOLE FOR POWER AND ONE 12" X 12" HAND HOLE FOR TELECOM.
- EXTEND EXISTING CIRCUIT TO NEW PEDESTRIAN LIGHT POLE LOCATION.
- NEW PEDESTRIAN LIGHT POLE LOCATION, PROVIDE NEW BASE, POLE AND LIGHT TO MATCH EXISTING SURROUNDING PEDESTRIAN DECORATIVE 'ANP' FIXTURES AND POLES. SEE DETAIL 6/E-102 PROVIDE UL LISTED LED KIT TO MATCH RETROFIT FIXTURES. COORDINATE WITH OWNER.
- EXISTING PEDESTRIAN LIGHT POLE LOCATION, PROVIDE NEW POLE AND LIGHT TO MATCH EXISTING SURROUNDING PEDESTRIAN DECORATIVE 'ANP' FIXTURES AND POLES, MOUNT TO EXISTING BASE AND CONNECT TO EXISTING CIRCUIT. PROVIDE UL LISTED LED KIT TO MATCH RETROFIT FIXTURES. COORDINATE WITH OWNER.

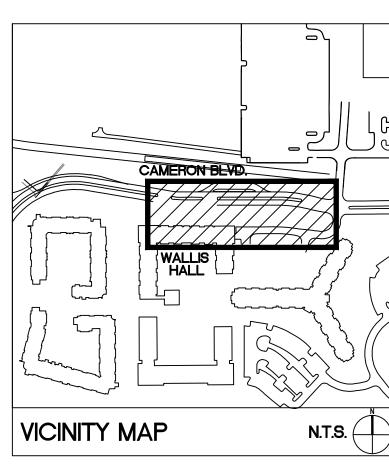

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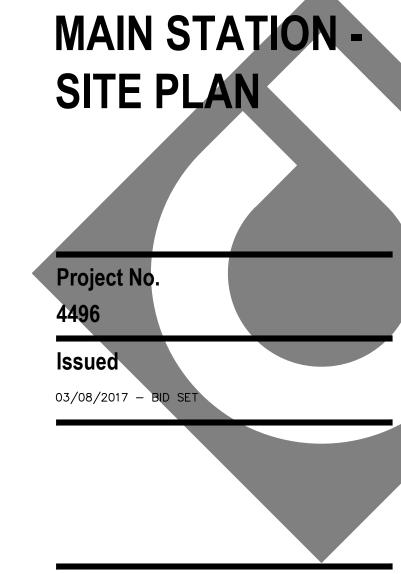


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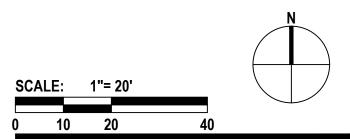
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Revised

1 03.17.17 ADDENDUM #1





E-20

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